
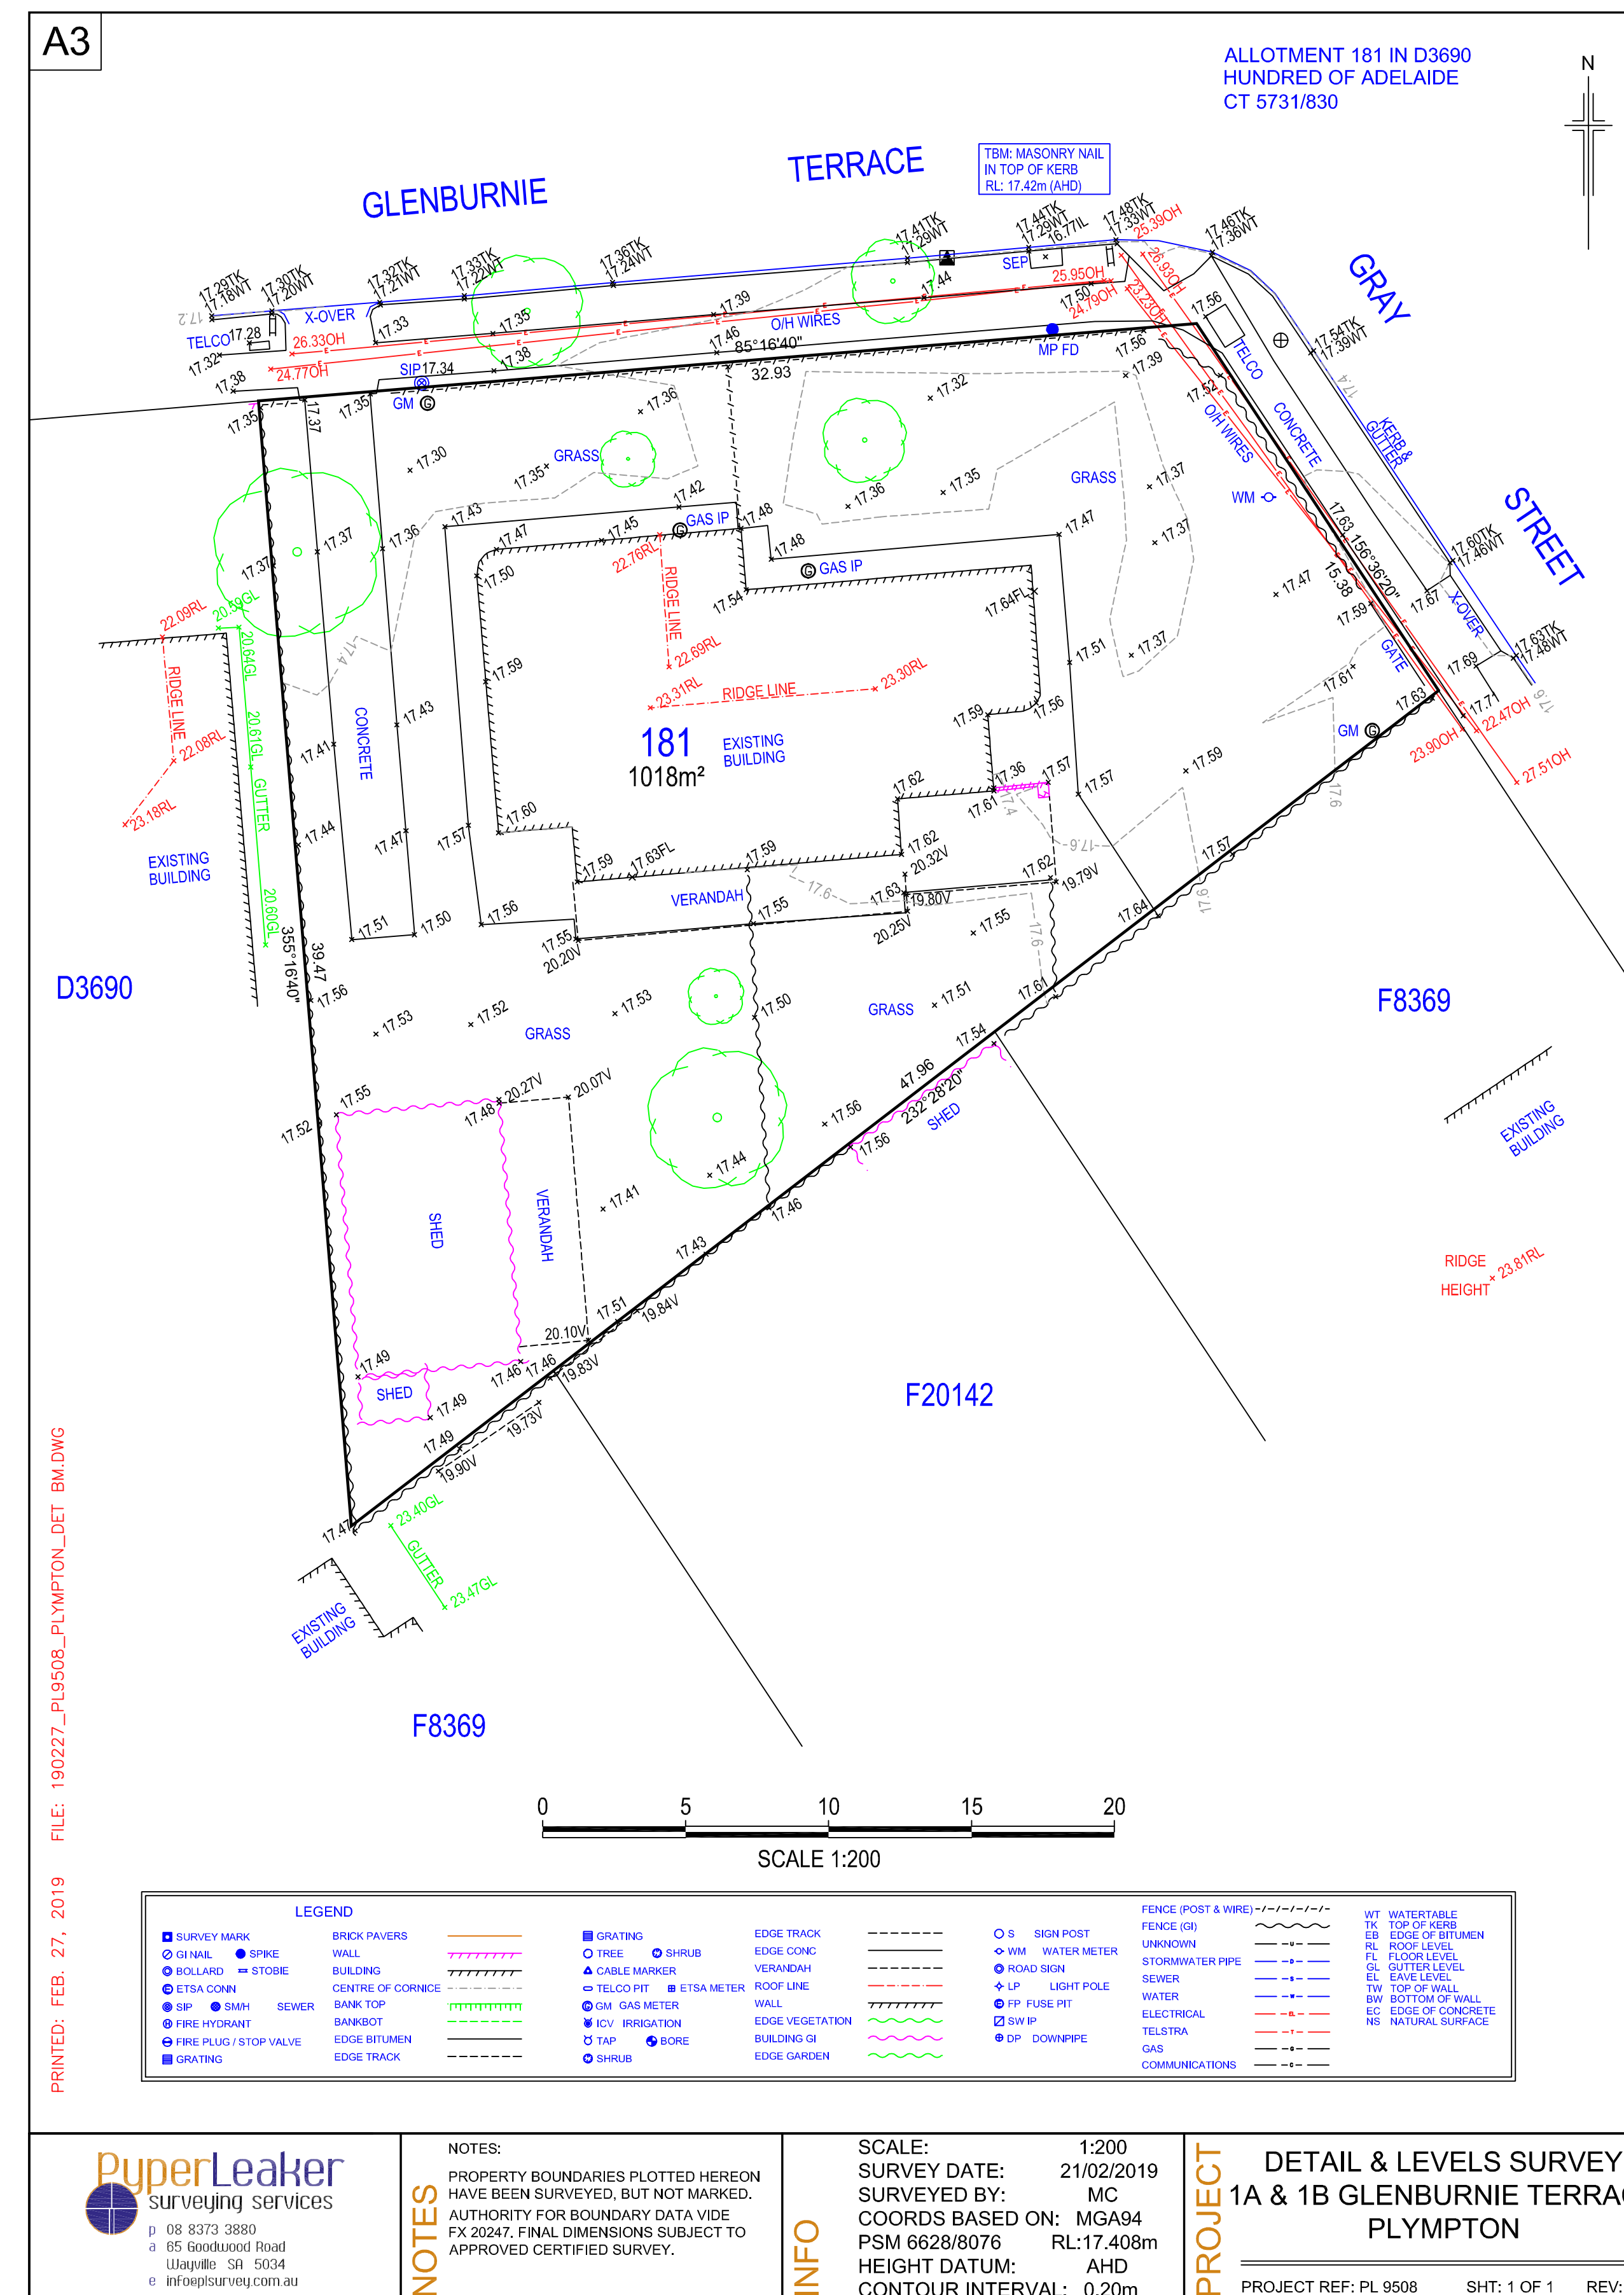



BUILDING APPLICATION
Proposed 32 apartments
1 Glenburnie Terrace PLYMPTON


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|---------|------------------------------|
| BL-00 | COVER |
| BL-01 | Proposed Site Plan |
| BL-02 | Ground Floor Plan |
| BL-02.1 | Carpark Mezzanine |
| BL-03 | Podium - Level 1Plan |
| BL-04 | Levels 2 & 3 Apartments |
| BL-05 | Level 4 Apartments |
| BL-06 | Roof Plan/ Typical Apartment |
| BL-07 | Elevations 1 |
| BL-08 | Elevations 2 |
| BL-09 | Section, Details |

THE SITE

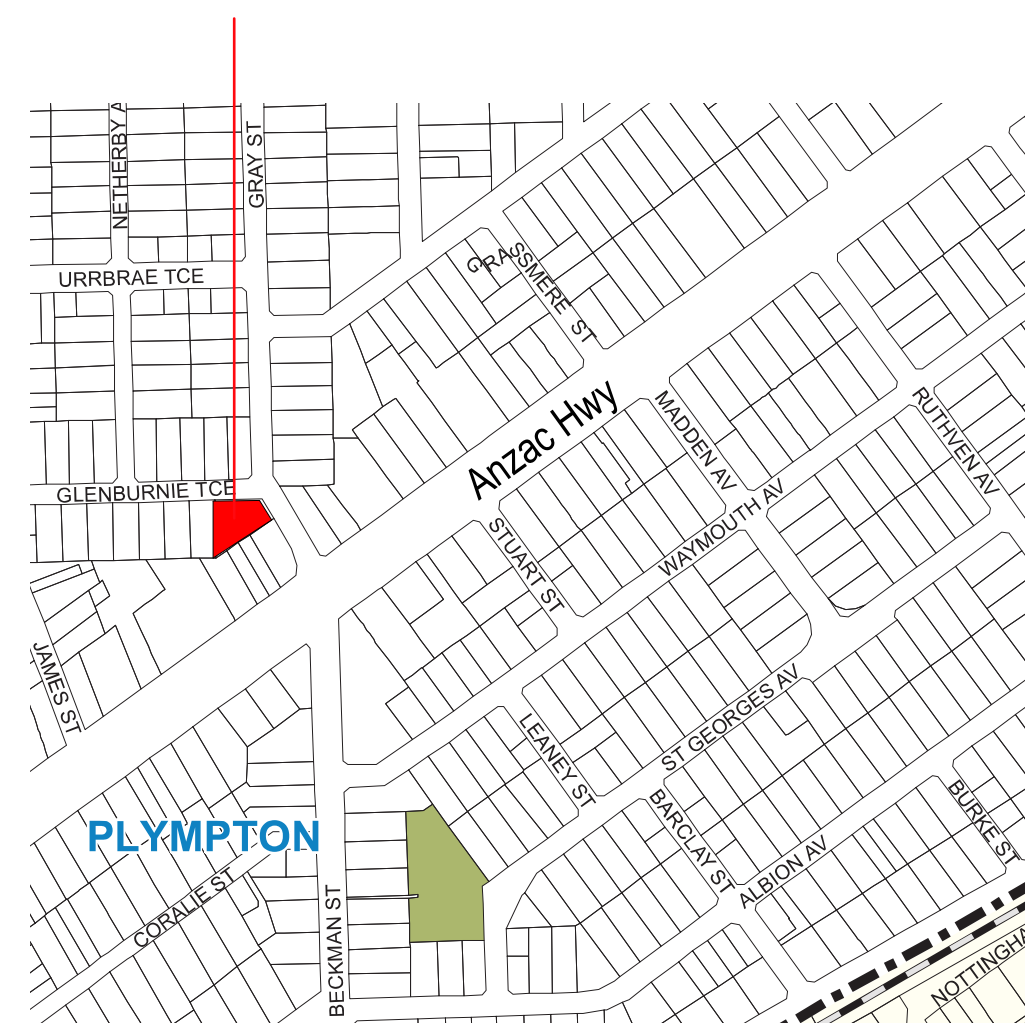

Rev B
Podium level raised 1500mm
Carpark mezzanine added with 27 stores
Stores removed from apartment floor plans.
Future roof top solar panels located.

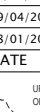		REB	
DATE		DESCRIPTION	
10/30/2018		LEVELS SAVED MEZANINE AND/DO	
11/01/2017		ISSUED FOR B.A. ASSESSMENT - BUILDING PERMIT	
18/01/2017		ISSUED FOR CONSULTANT DESIGN INPUT	
PREPARED BY: DAVID A. HOUSH IN THE OFFICE OF: DAVID A. HOUSH OF THE FIRM: DAVID A. HOUSH & ASSOCIATES			
THIS DOCUMENT IS THE PROPERTY OF THE ENGINEER. IT IS TO BE KEPT IN THE OFFICE OF THE ENGINEER. IT IS NOT TO BE REPRODUCED OR COPIED IN ANY MANNER WITHOUT THE WRITTEN PERMISSION OF THE ENGINEER.			
R B A N I Z E A R C H I T E C T PITY, LTD. A.B.N. 21 900 864 477 TEL: 1039 1989 FAX: 0302 8677 723 BRADSTY BLVD SUITE 600 PO BOX 108 BRISBANE QLD 4004			
The builder shall check and verify all dimensions refer any discrepancies to the Architect. Do not assume the dimensions. Owners shall not be used for construction purposes until issued by the Architect for construction.			
Client DSF Project Name PROPOSED 32 APARTMENTS 1 Glenburnie Tce, Plympton West Torrens			
I, DAVID A. HOUSH , a duly Licensed Professional Engineer in the State of California, hereby certify that I am the author of the above described project and that I am a duly Licensed Professional Engineer in the State of California.			
Drawing Title Cover - Existing Site plan			
Scale: AS SHOWN		Date: 18-04-2019	
Status: BCA		Job No.: 404-PLM	
Revision:		Drawing No.:	
Rev-A		BL-00	
Print Date:		30/05/2018	

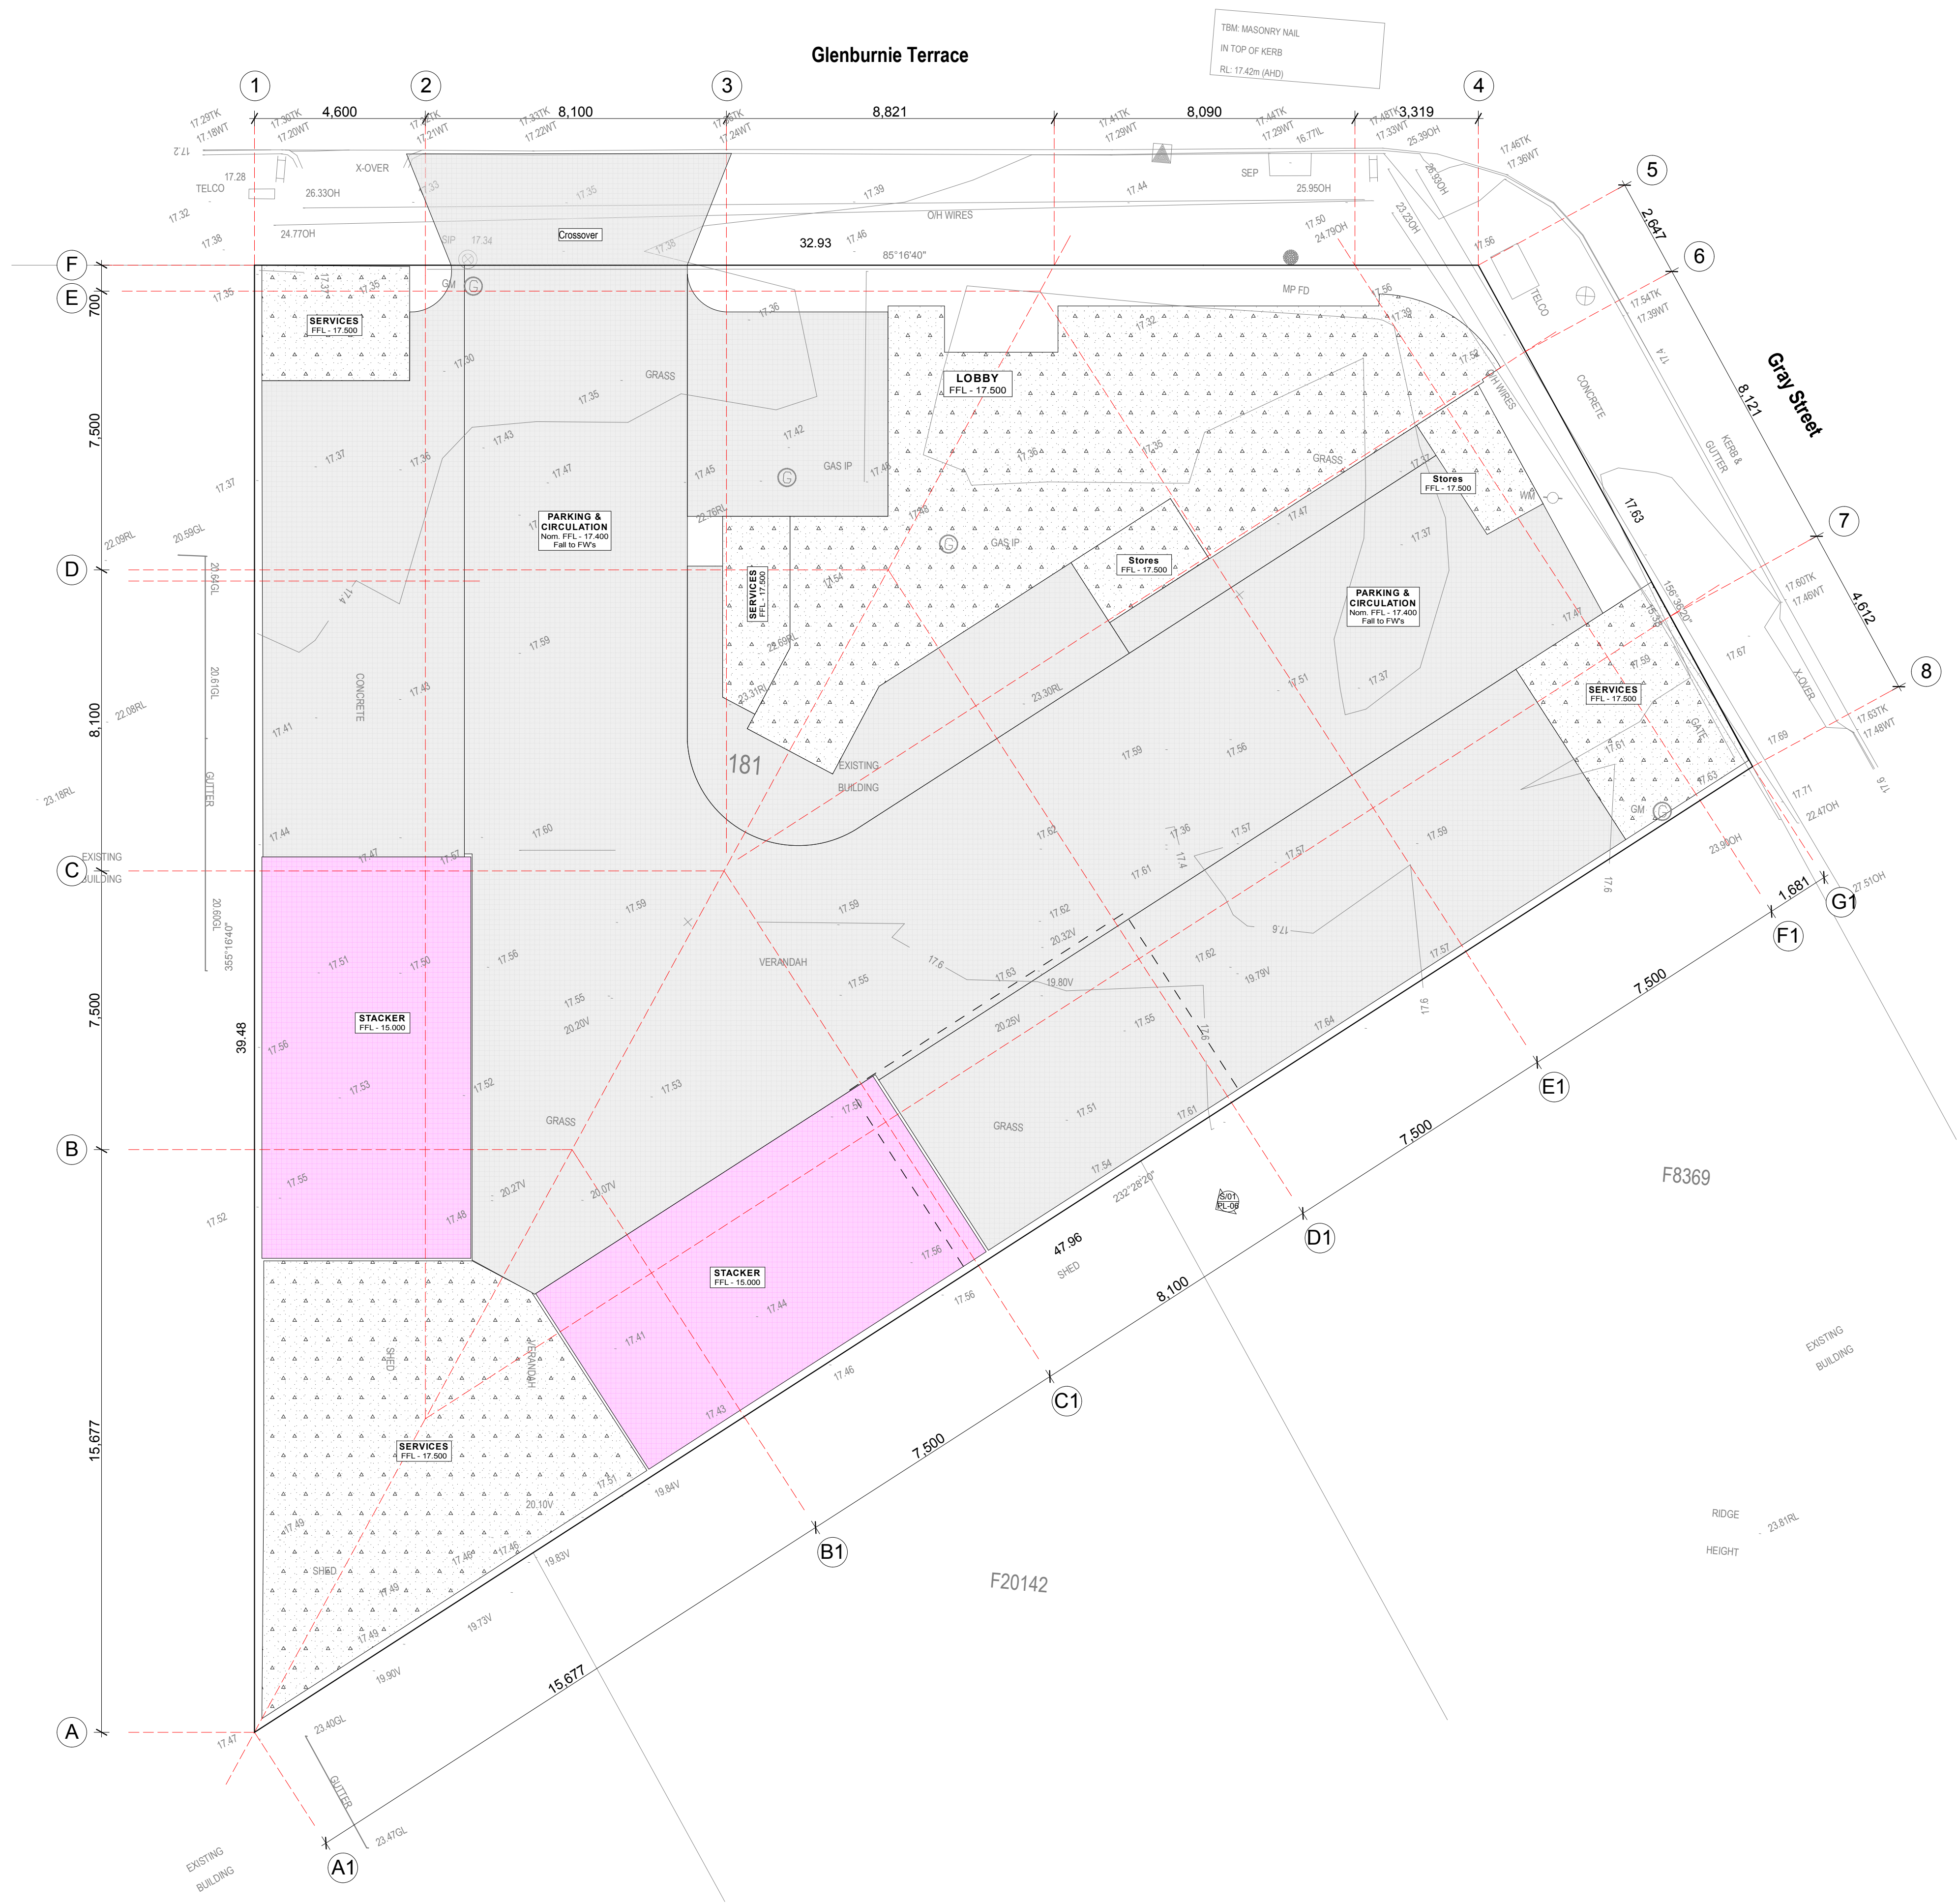

Proposed Site Plan
Scale 1:100




HALF SCALE at A3
FULL SCALE at A1

Proposed Site Plan

For consultant design
Printed 30/05/2019

REV	DATE	DESCRIPTION
8	20/05/2019	LEVELS BASED MEZZANINE ADDED
A	20/05/2019	ISSUED FOR R.C.A. ASSIGNMENT - BUILDING PERMIT
-	14/01/2019	ISSUED FOR CONSULTANT DESIGN INPUT
DESIGNED AND DRAWN BY P.T.T. IS THE OWNER OF THE COPYRIGHT OF THESE PLANS		
R U B A N I Z E ARCHITECT		
P.T.T. LTD. A.B.N. 21 693 044 427 TEL. 0838 1988 FAX 0838 2477 233 BAGOTT RD SUBIACO 6008 PO BOX 7000 SUBIACO 6008		
The builder shall check and verify all dimensions refer any discrepancies to the Architect. Do not scale the drawings. Drawings shall not be used for construction purposes until issued by the Architect for construction.		
Client: DSF Project Name: PROPOSED 32 APARTMENTS 1 Glenburnie Tce, Plympton West Torrens		
Drawing Title: Proposed Site Plan		
Scale: AS SHOWN	Date: 18-04-2019	
Status: BCA	Job No.: 480-PLM	
Revision: Rev-A	Drawing No.: BL-01	
Plot Date: 30/05/2019		

Glenburnie Terrace

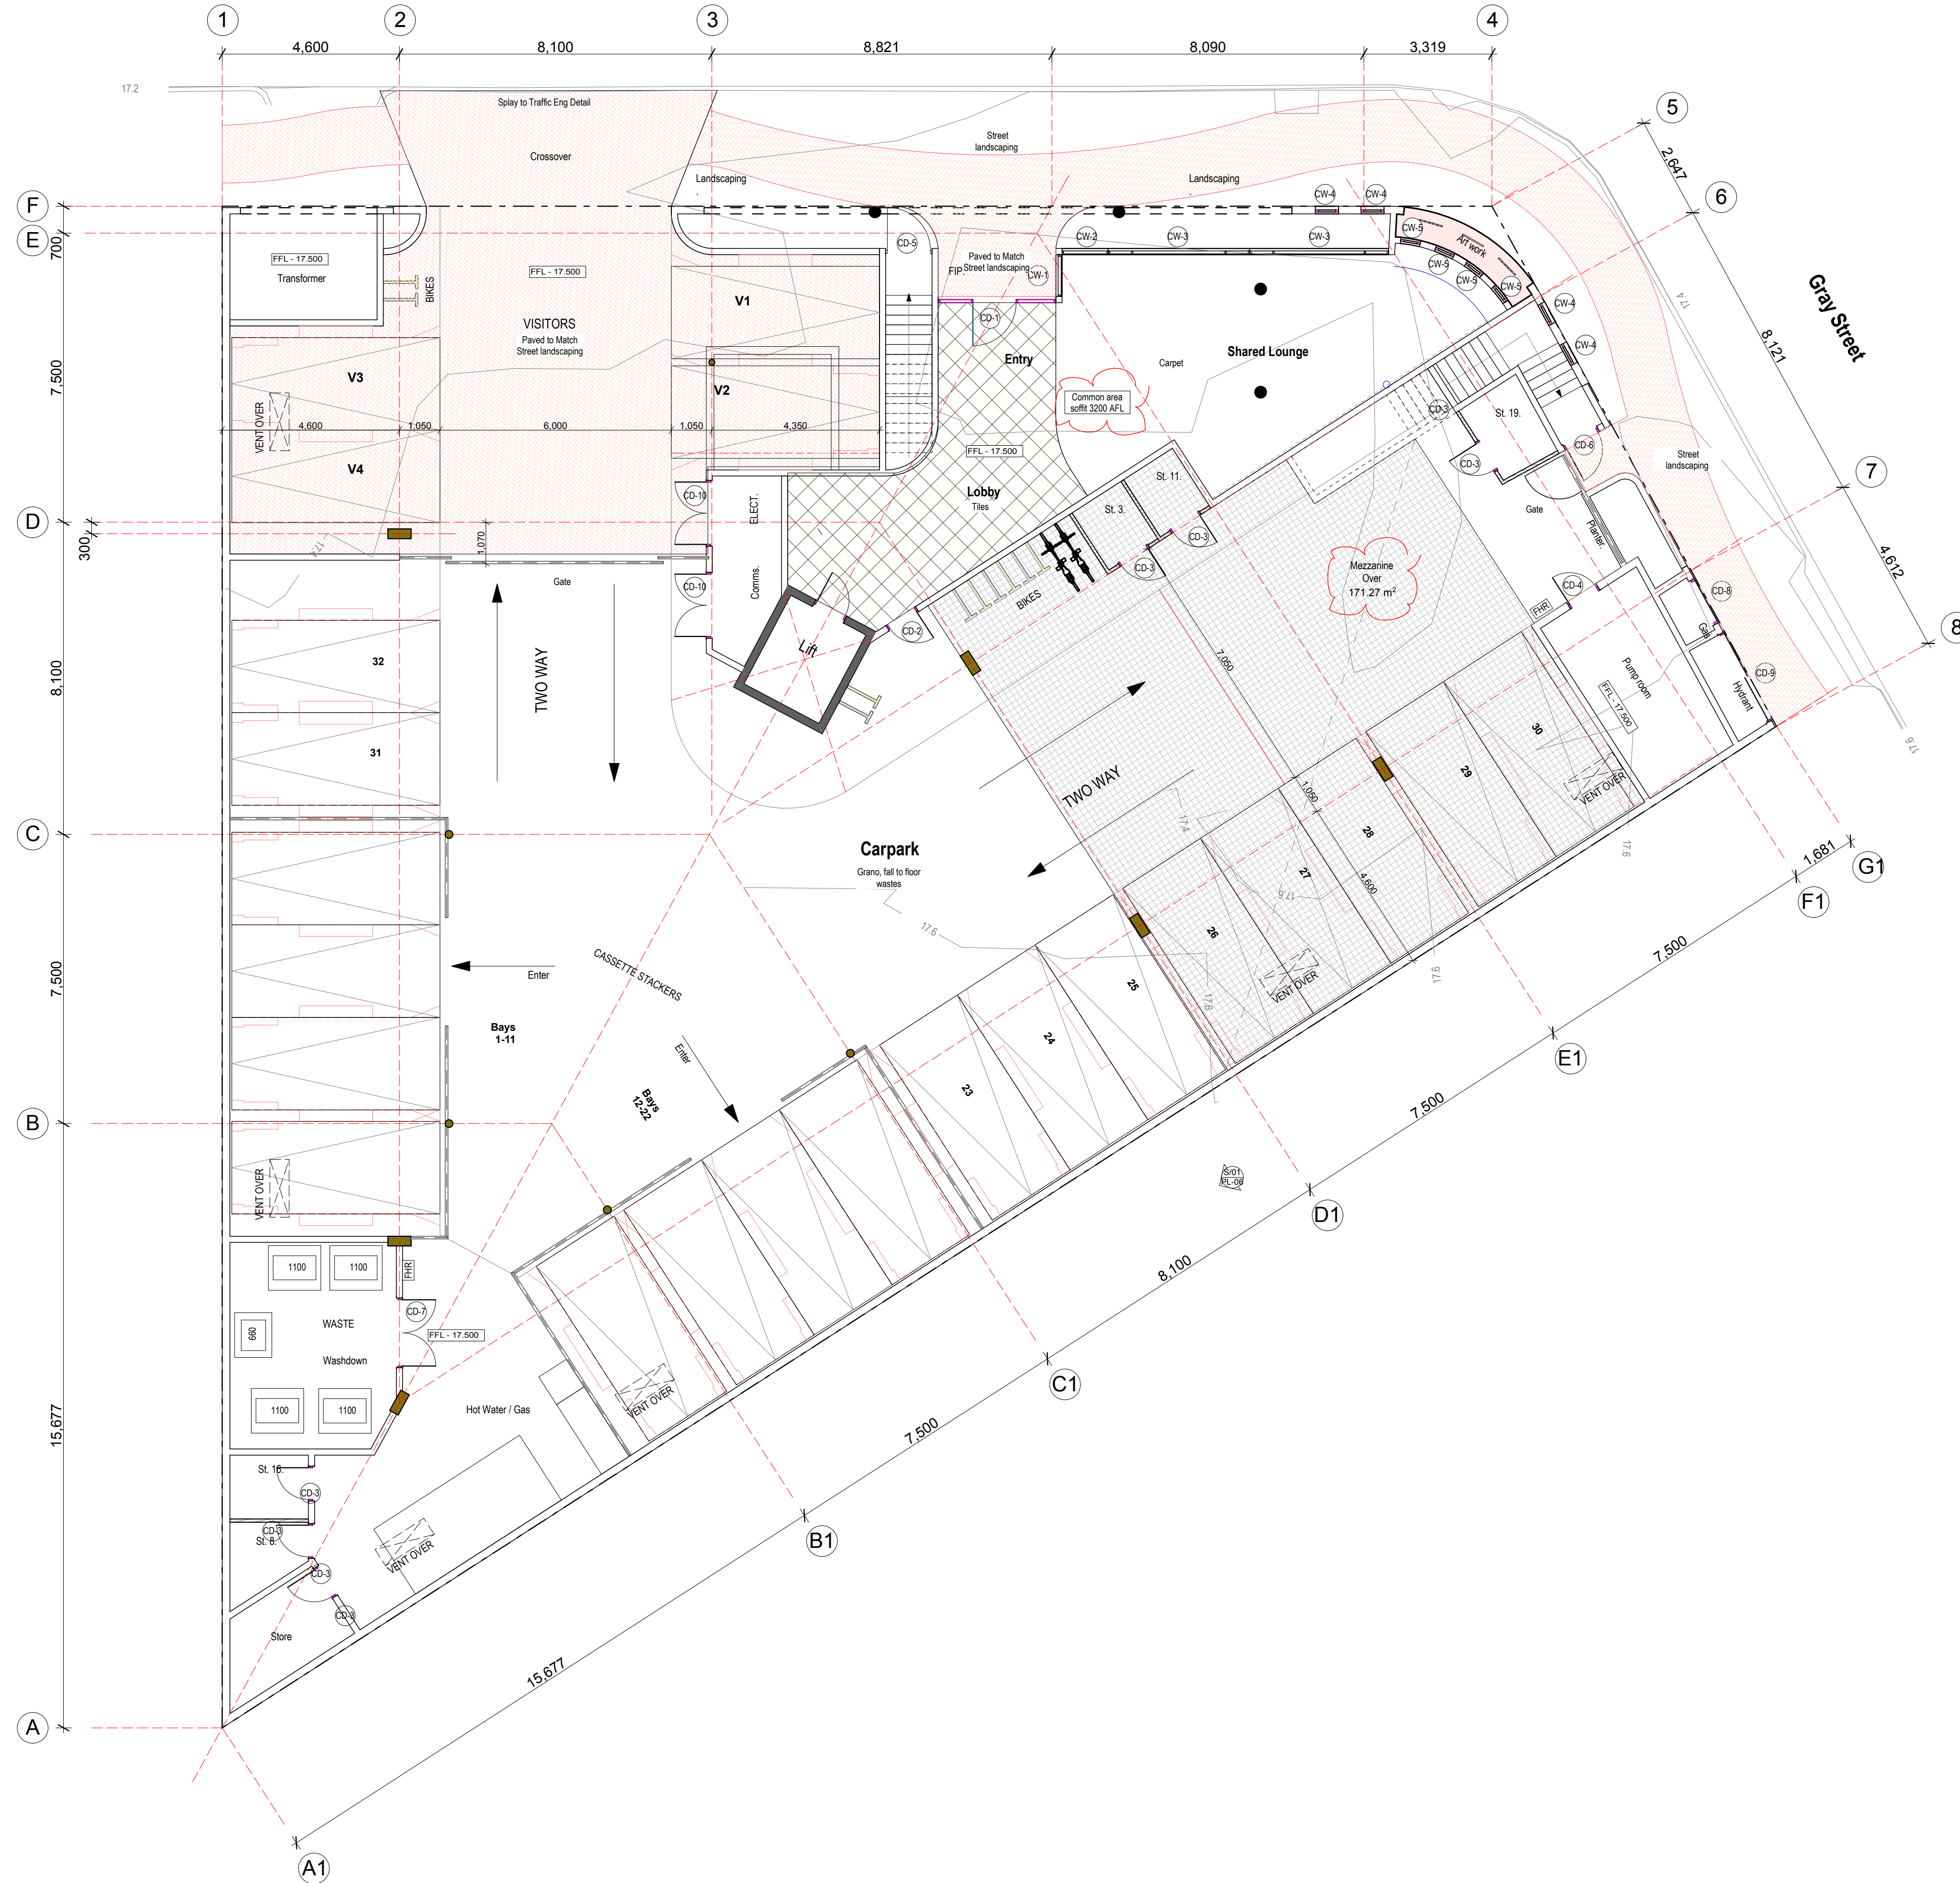

Ground floor Plan
Scale 1:100



HALF SCALE at A3
FULL SCALE at A1

Ground Floor plan

DOOR & WINDOW SCHEDULE 480 GRI, 1 Glenburnie Tce, Plympton

Rev 1 23-04-19

SCFD = Self Closing Fire Door - must be fitted with Hot Smoke Seals

All fire doors to be proprietary systems and must comply with AS1905.1 This door / window schedule to be read in conjunction with Fire engineer report

All residential Glazed doors (double glazed) to achieve an acoustic rating of RW29 unless otherwise stated

All residential Glazed windows (double glazed) to achieve an acoustic rating of RW29 unless otherwise stated


Sliding Doors - manual operation under a force of not more than 110N

Obscure glazing to all wet area windows


Ground Level					BCA Compliance Requirements	
Common	Item	Qty	Dimensions	Description	Finish	
	CD1	1	3050w x 3500h	Glazed door with sidelights and highlights	Powder coated commercial aluminium frame	Level transition at threshold. Recess sill as required. Resident entry security
	CD2	1	900w x 2100h	to suit 2040 x 820 Fire door	Steel frame, selected paint finish	SCFD. FRL - /120/30. Level transition at threshold. Resident entry security
	CD3	8	900w x 2400h	to suit 2340x820 Solid core single door	Steel frame, selected paint finish	SCFD. FRL - /120/30. Level transition at threshold
	CD4	1	900w x 2100h	to suit 2040 x 820 Fire door	Steel frame, selected paint finish	Latch or keyless operation from inside. Level transition at threshold.
	CD5	1	1200w x 3200h	Glazed door with highlight	Powder coated commercial aluminium frame	Latch or keyless operation from inside. Level transition at threshold.
	CD6	1	950w x 2400h	to suit 2340 x 820 Aluminium glazed door	Powder coated commercial aluminium frame	
	CD7	1	1700w x 2400h	to suit 2x2340x820 Solid core double doors	Steel frame, selected paint finish	Door to gas supply authority requirements
	CD8	1	1300w x 2400h	to suit vented roller door	Steel frame, selected paint finish	Doors to fire brigade requirements
	CD9	1	2600w x 1500h	Hydrant cupboard doors	Steel frame, selected paint finish	no combustible, smoke seals
	CD10	2	1700w x 1500h	to suit 2x820 Solid core double doors	Steel frame, selected paint finish	
NO R/w req.	CW1	1	1080w x 2900h	Fixed Glazed Window with highlight	Powder coated commercial aluminium frame	
	CW2	1	1200w x 2900h	Fixed Glazed Window with highlight	Powder coated commercial aluminium frame	
	CW3	2	3630w x 2900h	Fixed Glazed Window with sidelights & highlights	Powder coated commercial aluminium frame	
	CW4	4	600w x 1800h	Fixed Glazed Window	Powder coated commercial aluminium frame	
	CW5	4	600w x 1800h	Fixed Glazed Window	Powder coated commercial aluminium frame	

Ground Floor, Door Window Shedule

For more detail refer to the full schedule in the specification

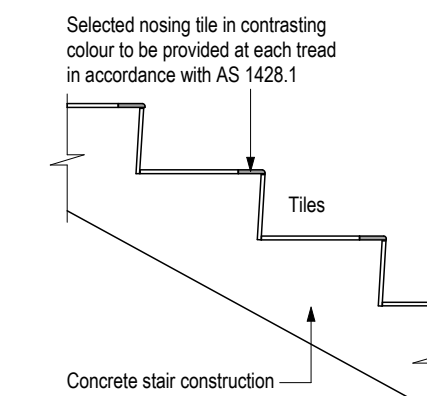

Stair Section
Scale 1:20

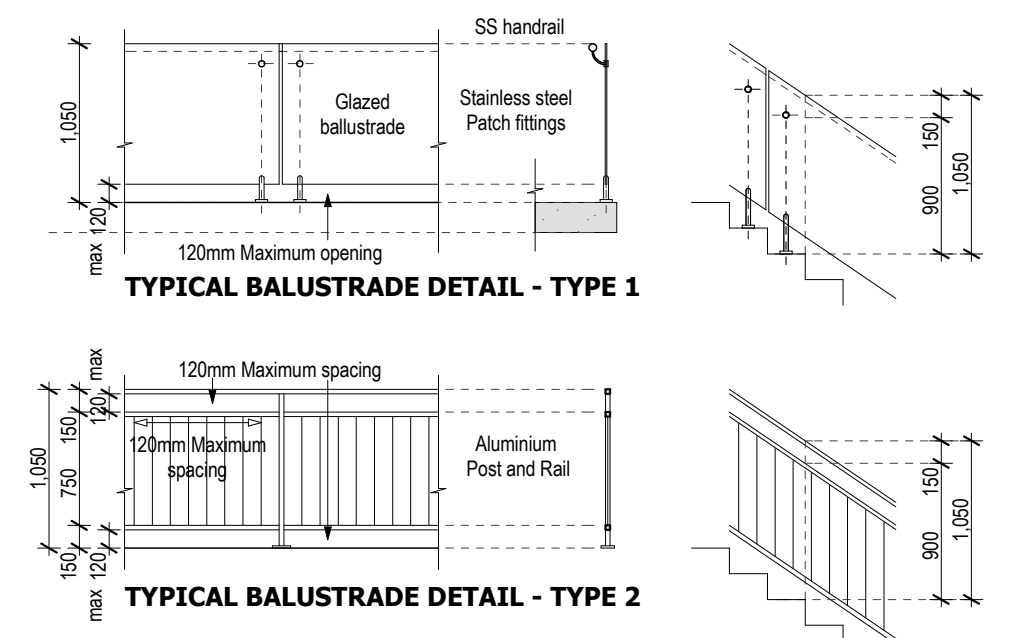

Typical Balustrades
Scale 1:50

REV	DATE	DESCRIPTION
1	18/05/2019	LEVELS BASED MEZZANINE ADDED
2	20/04/2019	ISSUED FOR R/C ASSOCIATION - BUILDING PERMIT
3	14/01/2019	ISSUED FOR CONSULTANT DESIGN INPUT

THESE DRAWINGS ARE THE PROPERTY OF THE ARCHITECT
UNLESS OTHERWISE STATED BY THE ARCHITECT

Client:
DSF
Project Name:
PROPOSED 32 APARTMENTS
1 Glenburnie Tce, Plympton
West Torrens

Drawing Title:
Ground Floor plan


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Status: BCA Job No.: 480-PLM

Revision:
Rev-A Drawing No.: BL-02

Plot Date: 30/05/2019


For consultant design
Printed 30/05/2019

B	10-05-2019 LEVELS RAMP MEZZANINE ADDED
A	11-05-2019 QUOTES FOR BGA ASSIGNMENT - BUILDING ARMED
E	18-01-2019 ISSUED FOR CONSULTANT DESIGN INPUT
R	REVISION DATE DESCRIPTION
<small>(THIS DRAWING IS THE PROPERTY OF TAYLOR DUNN)</small>	
© Taylor Dunn R&B Architects	
PITY LTD.	A.B.N. 21 9594 0040
TEL: 0800 988 744	FAX: 0202 6477
223 BRADSTY RD BURROUGHS ROAD	
PO BOX 106 BURROUGHS ROAD	
The builder shall check and verify all dimensions referred anywhere to this Architect. Do not evade the dimension. Dimension shall be used for construction purposes unless told by the architect for construction.	
Client	DSCF
Project Name	PROPOSED SC2 APARTMENTS
Site Address	1 Glenburnie Terrace, Plympton
West Torrens	
<small>* This drawing has been prepared under contract between Taylor Dunn Pty Ltd as project manager &</small>	
Drawing Title:	Carpark Mezzanine
Status:	AS SHOWN Date: 18-04-2019
Status:	BCA Job No.: 480-PLM
Revision:	Drawing no:
Rev-A	BL-021
Print Date:	30/05/2019

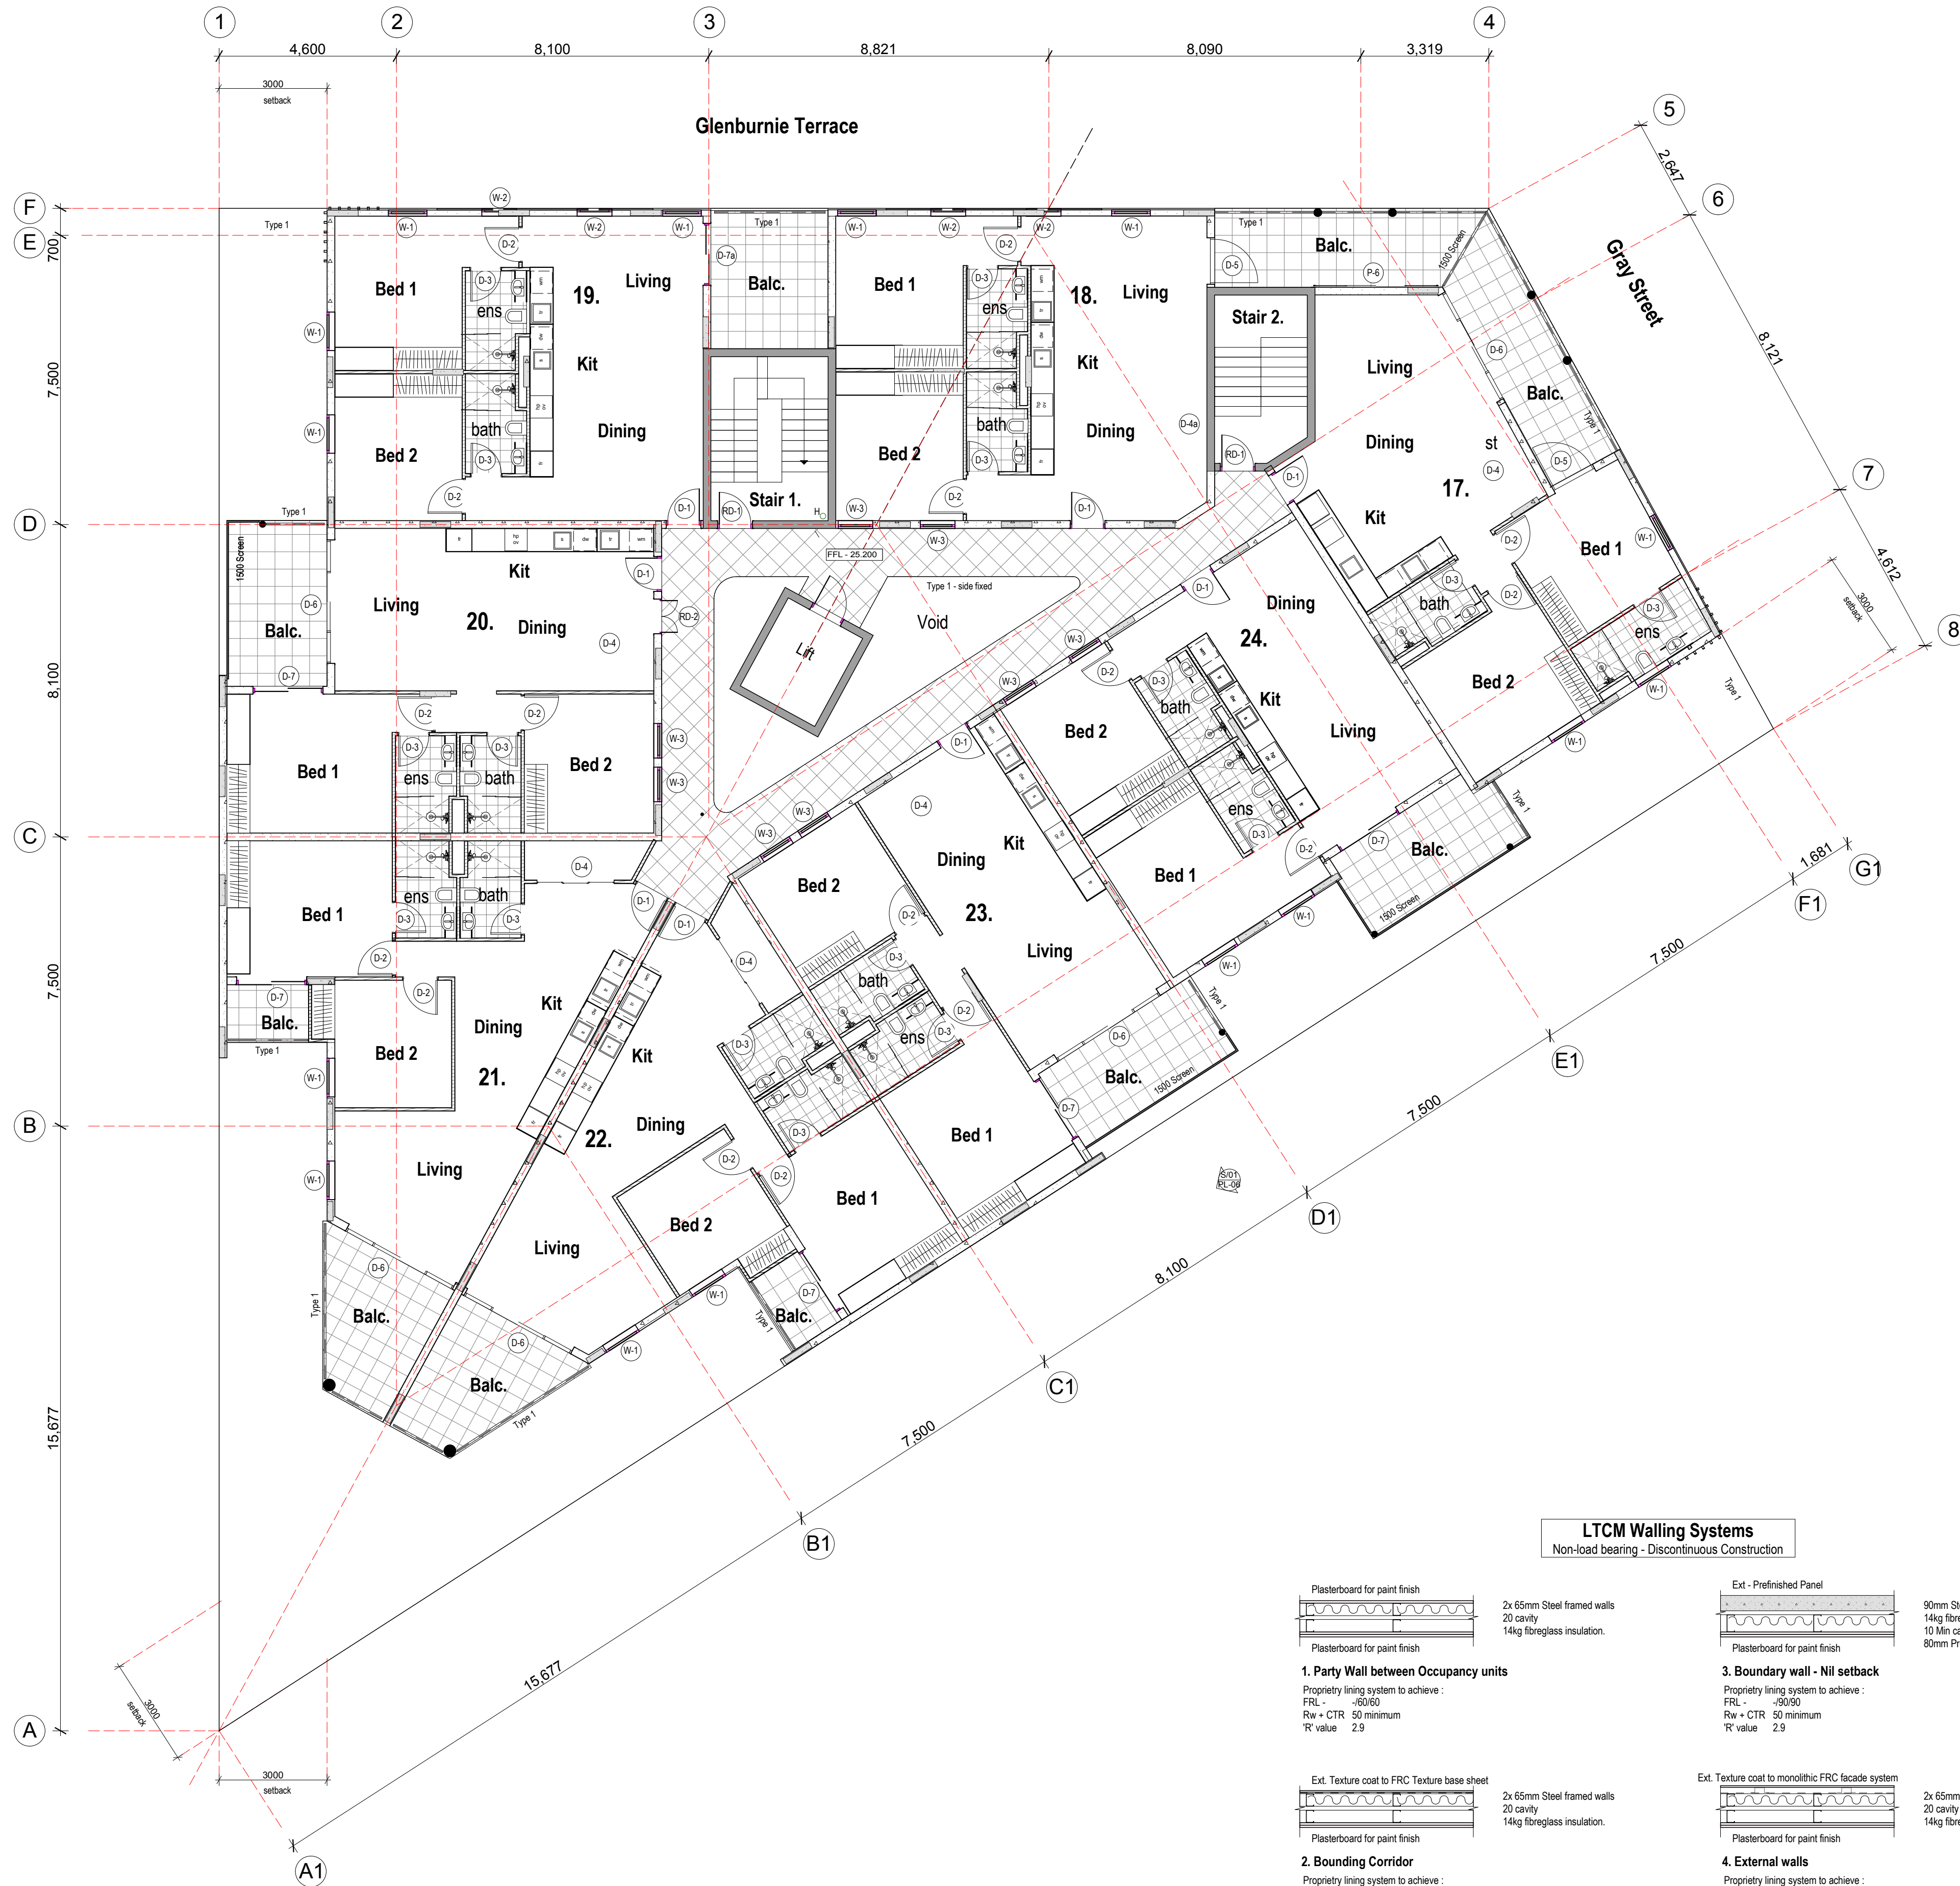

Levels 2 & 3 Apartments
Scale 1:100


Wall Systems
Scale 1:20

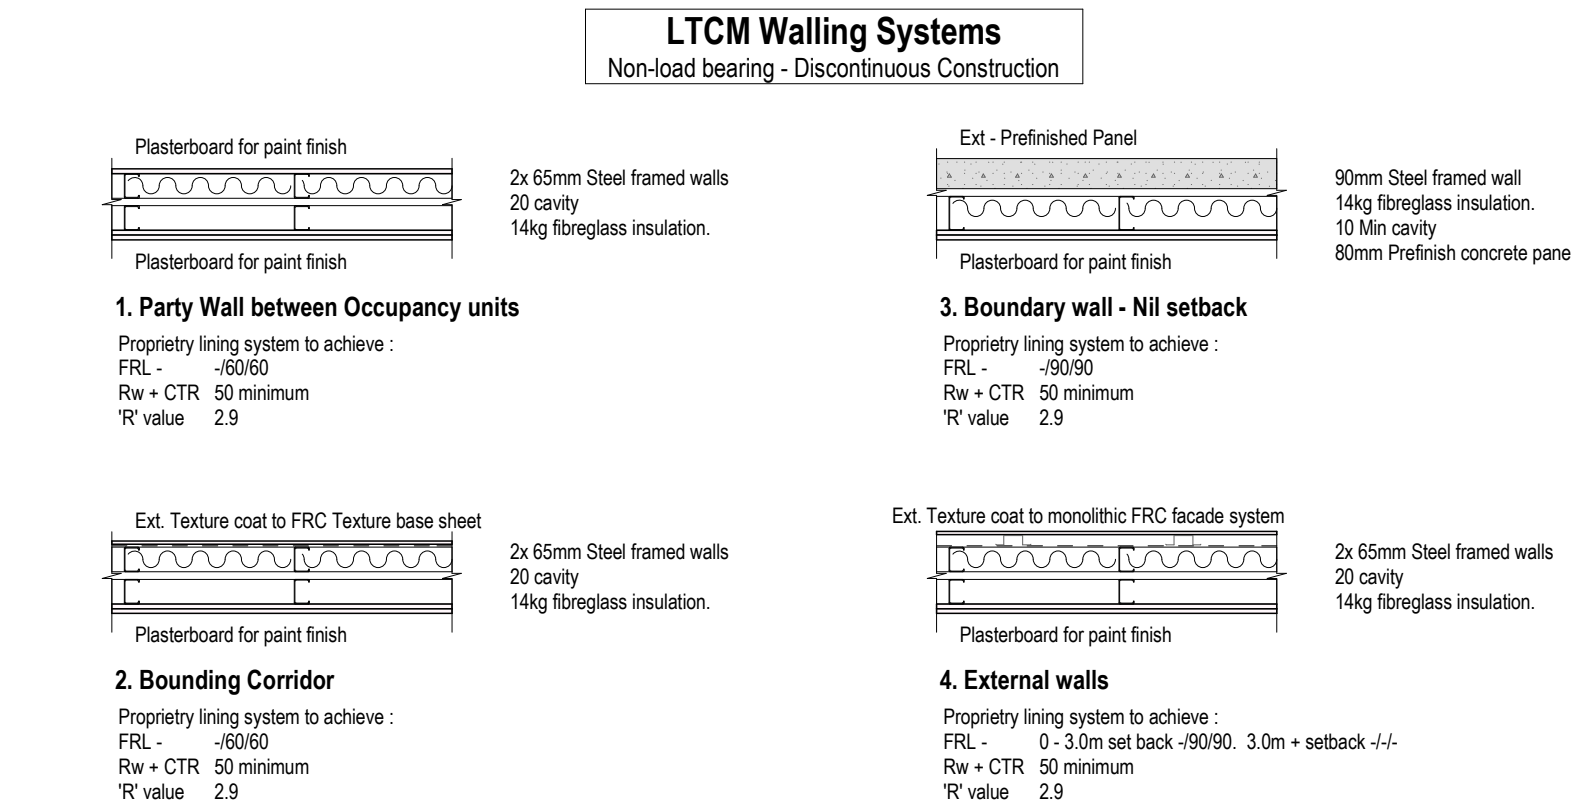



DOOR & WINDOW SCHEDULE 480 GRI, 1 Glenburnie Tce, Plympton
Rev 1 23-04-19
SCFD = Self Closing Fire Door - must be fitted with Hot Smoke Seals
All fire doors to be proprietary systems and must comply with AS1905.1 This door / window schedule to be read in conjunction with Fire engineer report
All residential Glazed doors (double glazed) to achieve an acoustic rating of RW29 unless otherwise stated
All residential Glazed windows (double glazed) to achieve an acoustic rating of RW29 unless otherwise stated
Sliding Doors - manual operation under a force of not more 110N
Obscure glazing to all wet area windows

TYPICAL APARTMENT	Item	Dimensions	Description	Finish	BCA Compliance Requirements
	D1	900w x 2400h	to suit 2340x820 Fire door	Steel frame, selected paint finish	SCFD, FRL - /60/30, Latch or keyless operation from inside. Level transition at threshold. Minimum sound transmission rating of no less than 30Rw
	D2	900w x 2400h	to suit 2340 x 820 single door	Steel frame, selected paint finish	
	D3	800w x 2400h	to suit 2340 x 720 single door	Steel frame, selected paint finish	
	D4	2000w x 2400h	to suit 2340 x 650 Panel sliding doors	By Cabinet maker	
	D5	1200w x 2400h	to suit 2340x1120 Aluminium glazed door	Powder coated aluminium frame, clear glazed	
	D6	3150w x 2400h	Aluminium, Centre Sliding door	Powder coated aluminium frame, clear glazed	
	D7	1800w x 2400h	Aluminium, Sliding door	Powder coated aluminium frame, clear glazed	
	W1	1000w x 1600h	Aluminium, Awning window	Powder coated aluminium frame	Maximum opening 120mm
	W2	900w x 1900h	Aluminium, Awning window	Powder coated aluminium frame	Maximum opening 120mm
	W3	900w x 900h	Aluminium, Awning window	Powder coated aluminium frame	1500 sill, Maximum opening 120mm
	W4	1600w x 1000h	Aluminium, Awning window	Powder coated aluminium frame	Maximum opening 120mm


Typical Apartment Door Window Shedule
For more detail refer to the full schedule in the specification

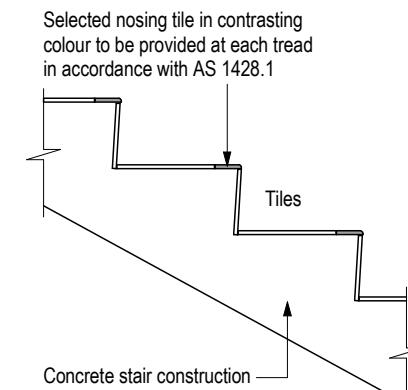


Stair Section
Scale 1:20

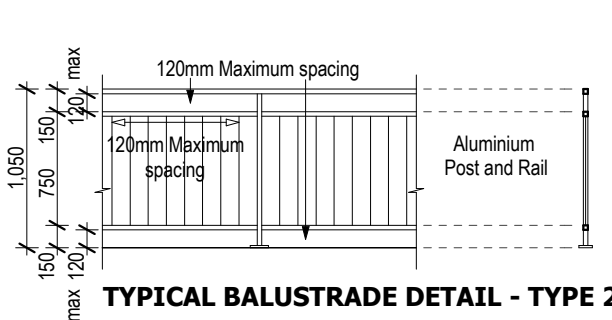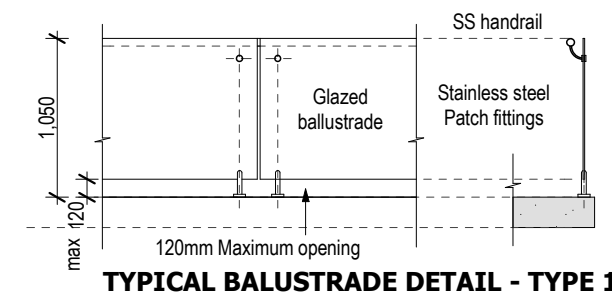


Typical Balustrades
Scale 1:50

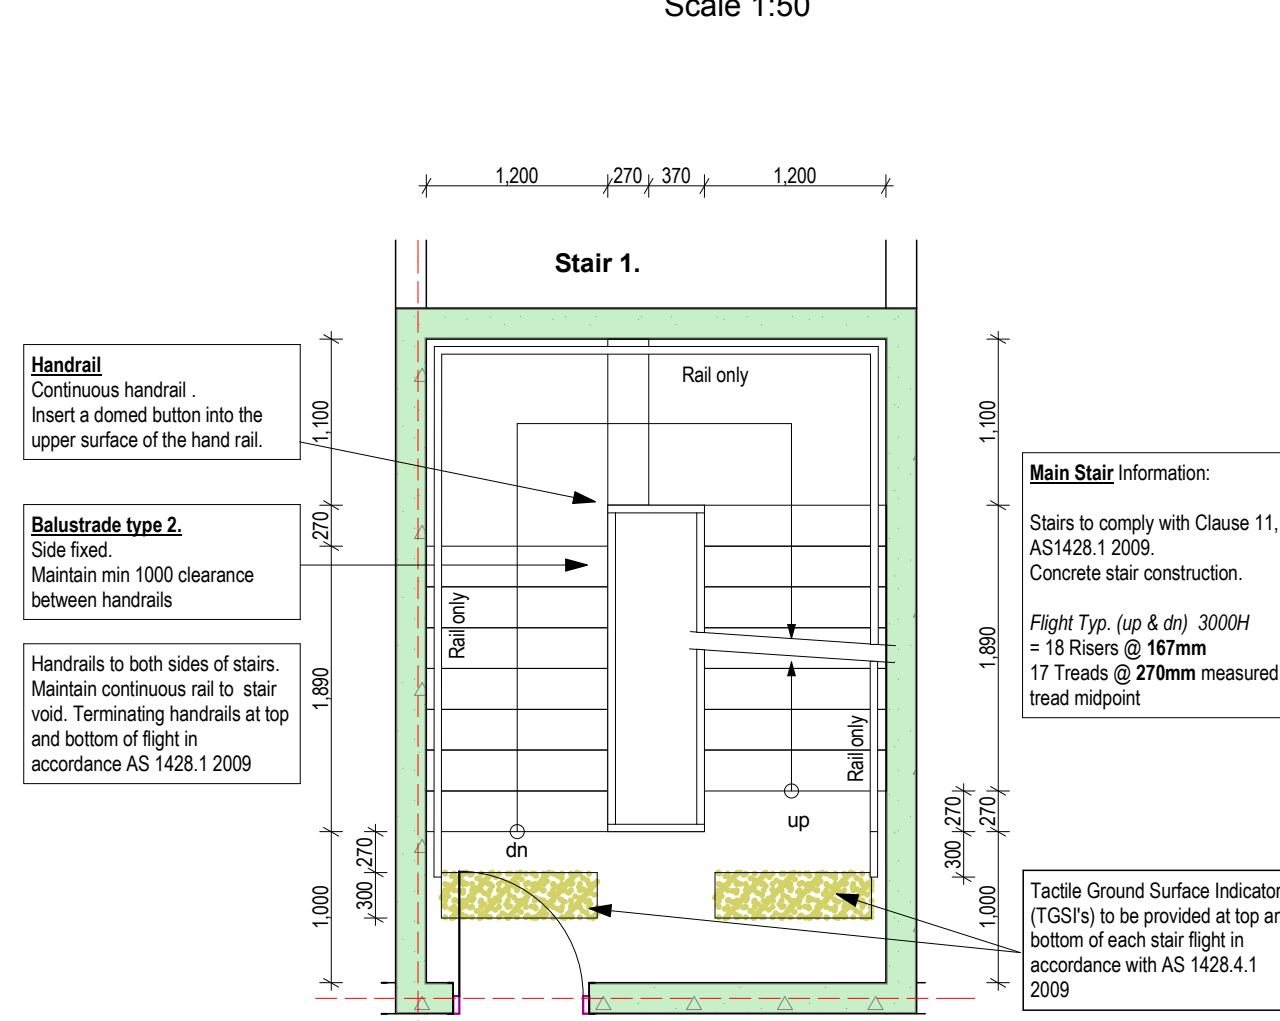

Stair 1.
Scale 1:50

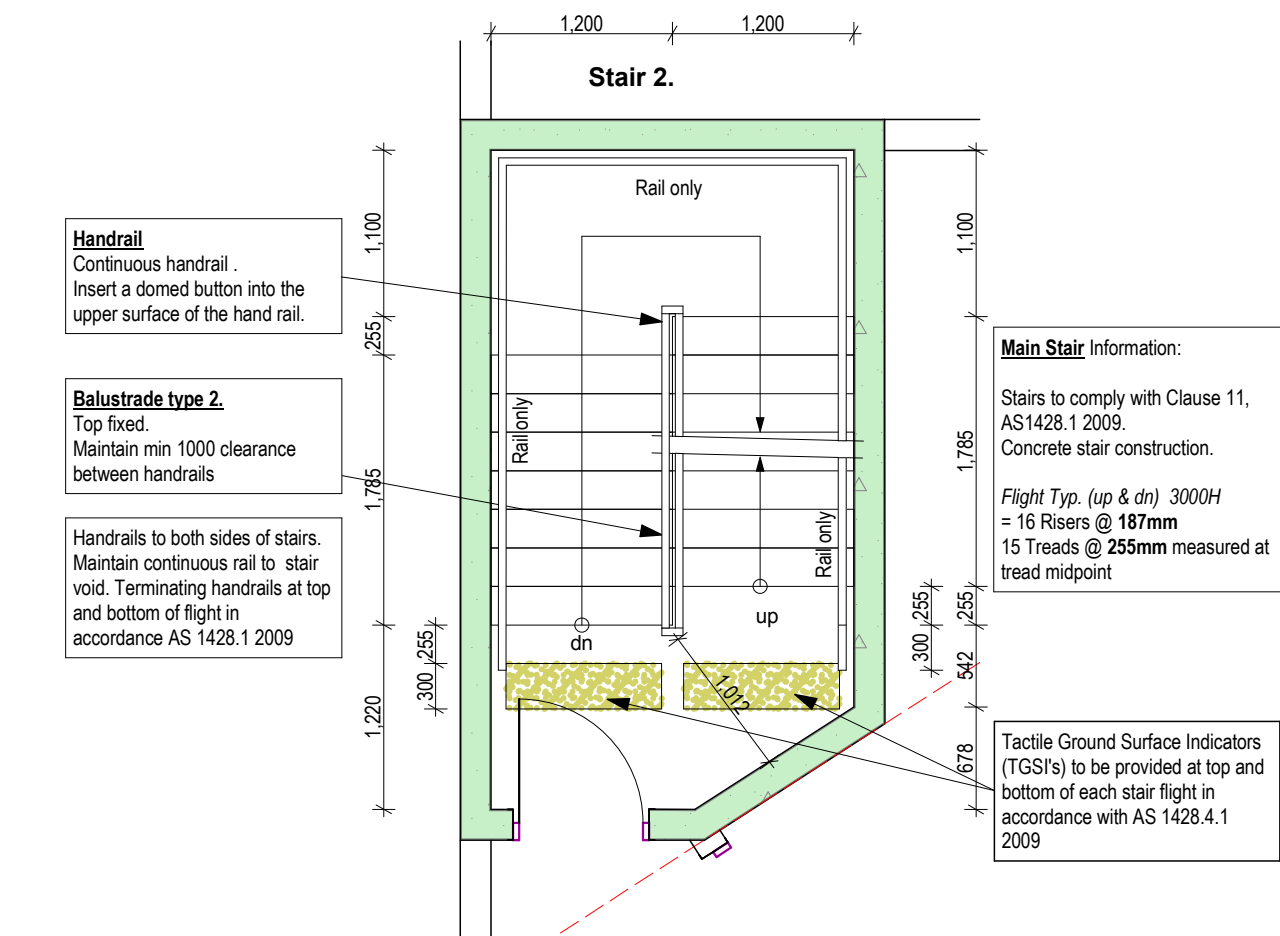

Stair 2.
Scale 1:50

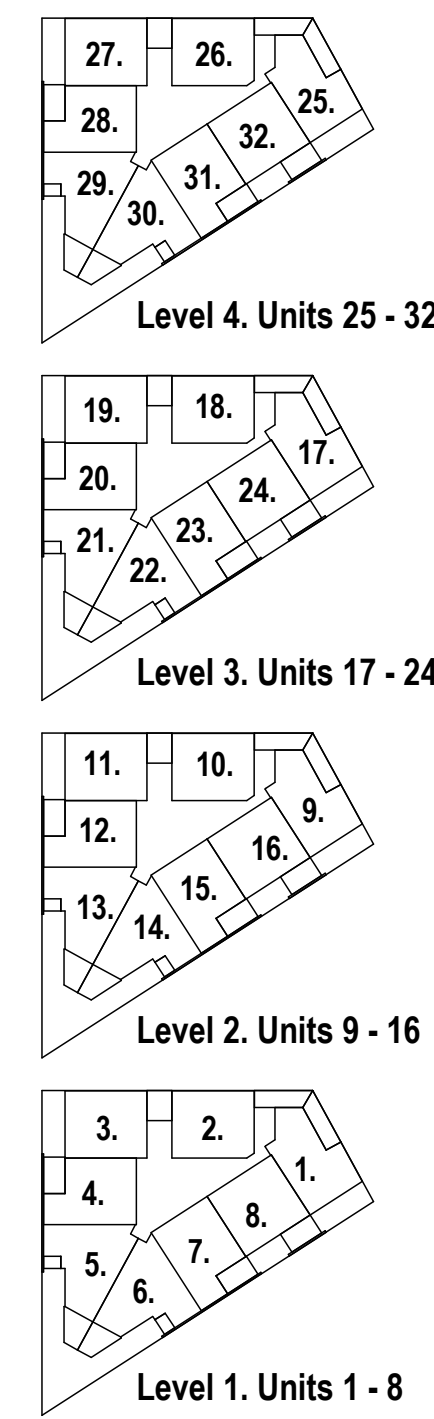

REV	DATE	DESCRIPTION
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2	18/04/2019	ISSUED FOR RFP
3	18/04/2019	ISSUED FOR RFP
4	18/04/2019	ISSUED FOR RFP
5	18/04/2019	ISSUED FOR RFP
6	18/04/2019	ISSUED FOR RFP
7	18/04/2019	ISSUED FOR RFP
8	18/04/2019	ISSUED FOR RFP
9	18/04/2019	ISSUED FOR RFP
10	18/04/2019	ISSUED FOR RFP
11	18/04/2019	ISSUED FOR RFP
12	18/04/2019	ISSUED FOR RFP
13	18/04/2019	ISSUED FOR RFP
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20	18/04/2019	ISSUED FOR RFP
21	18/04/2019	ISSUED FOR RFP
22	18/04/2019	ISSUED FOR RFP
23	18/04/2019	ISSUED FOR RFP
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28	18/04/2019	ISSUED FOR RFP
29	18/04/2019	ISSUED FOR RFP
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32	18/04/2019	ISSUED FOR RFP




HALF SCALE at A3
FULL SCALE at A1

Levels 2 & 3 Apartments


For consultant design
Printed 30/05/2019

Client: DSF	Project Name: PROPOSED 32 APARTMENTS
Address: 1 Glenburnie Tce, Plympton	City: West Torrens
Drawing Title: Levels 2 & 3 Apartments	Scale: AS SHOWN
Revision: Rev-A	Date: 18-04-2019
Plot Date: 30/05/2019	Job No.: 480-PLM
	Drawing No.: BL-04

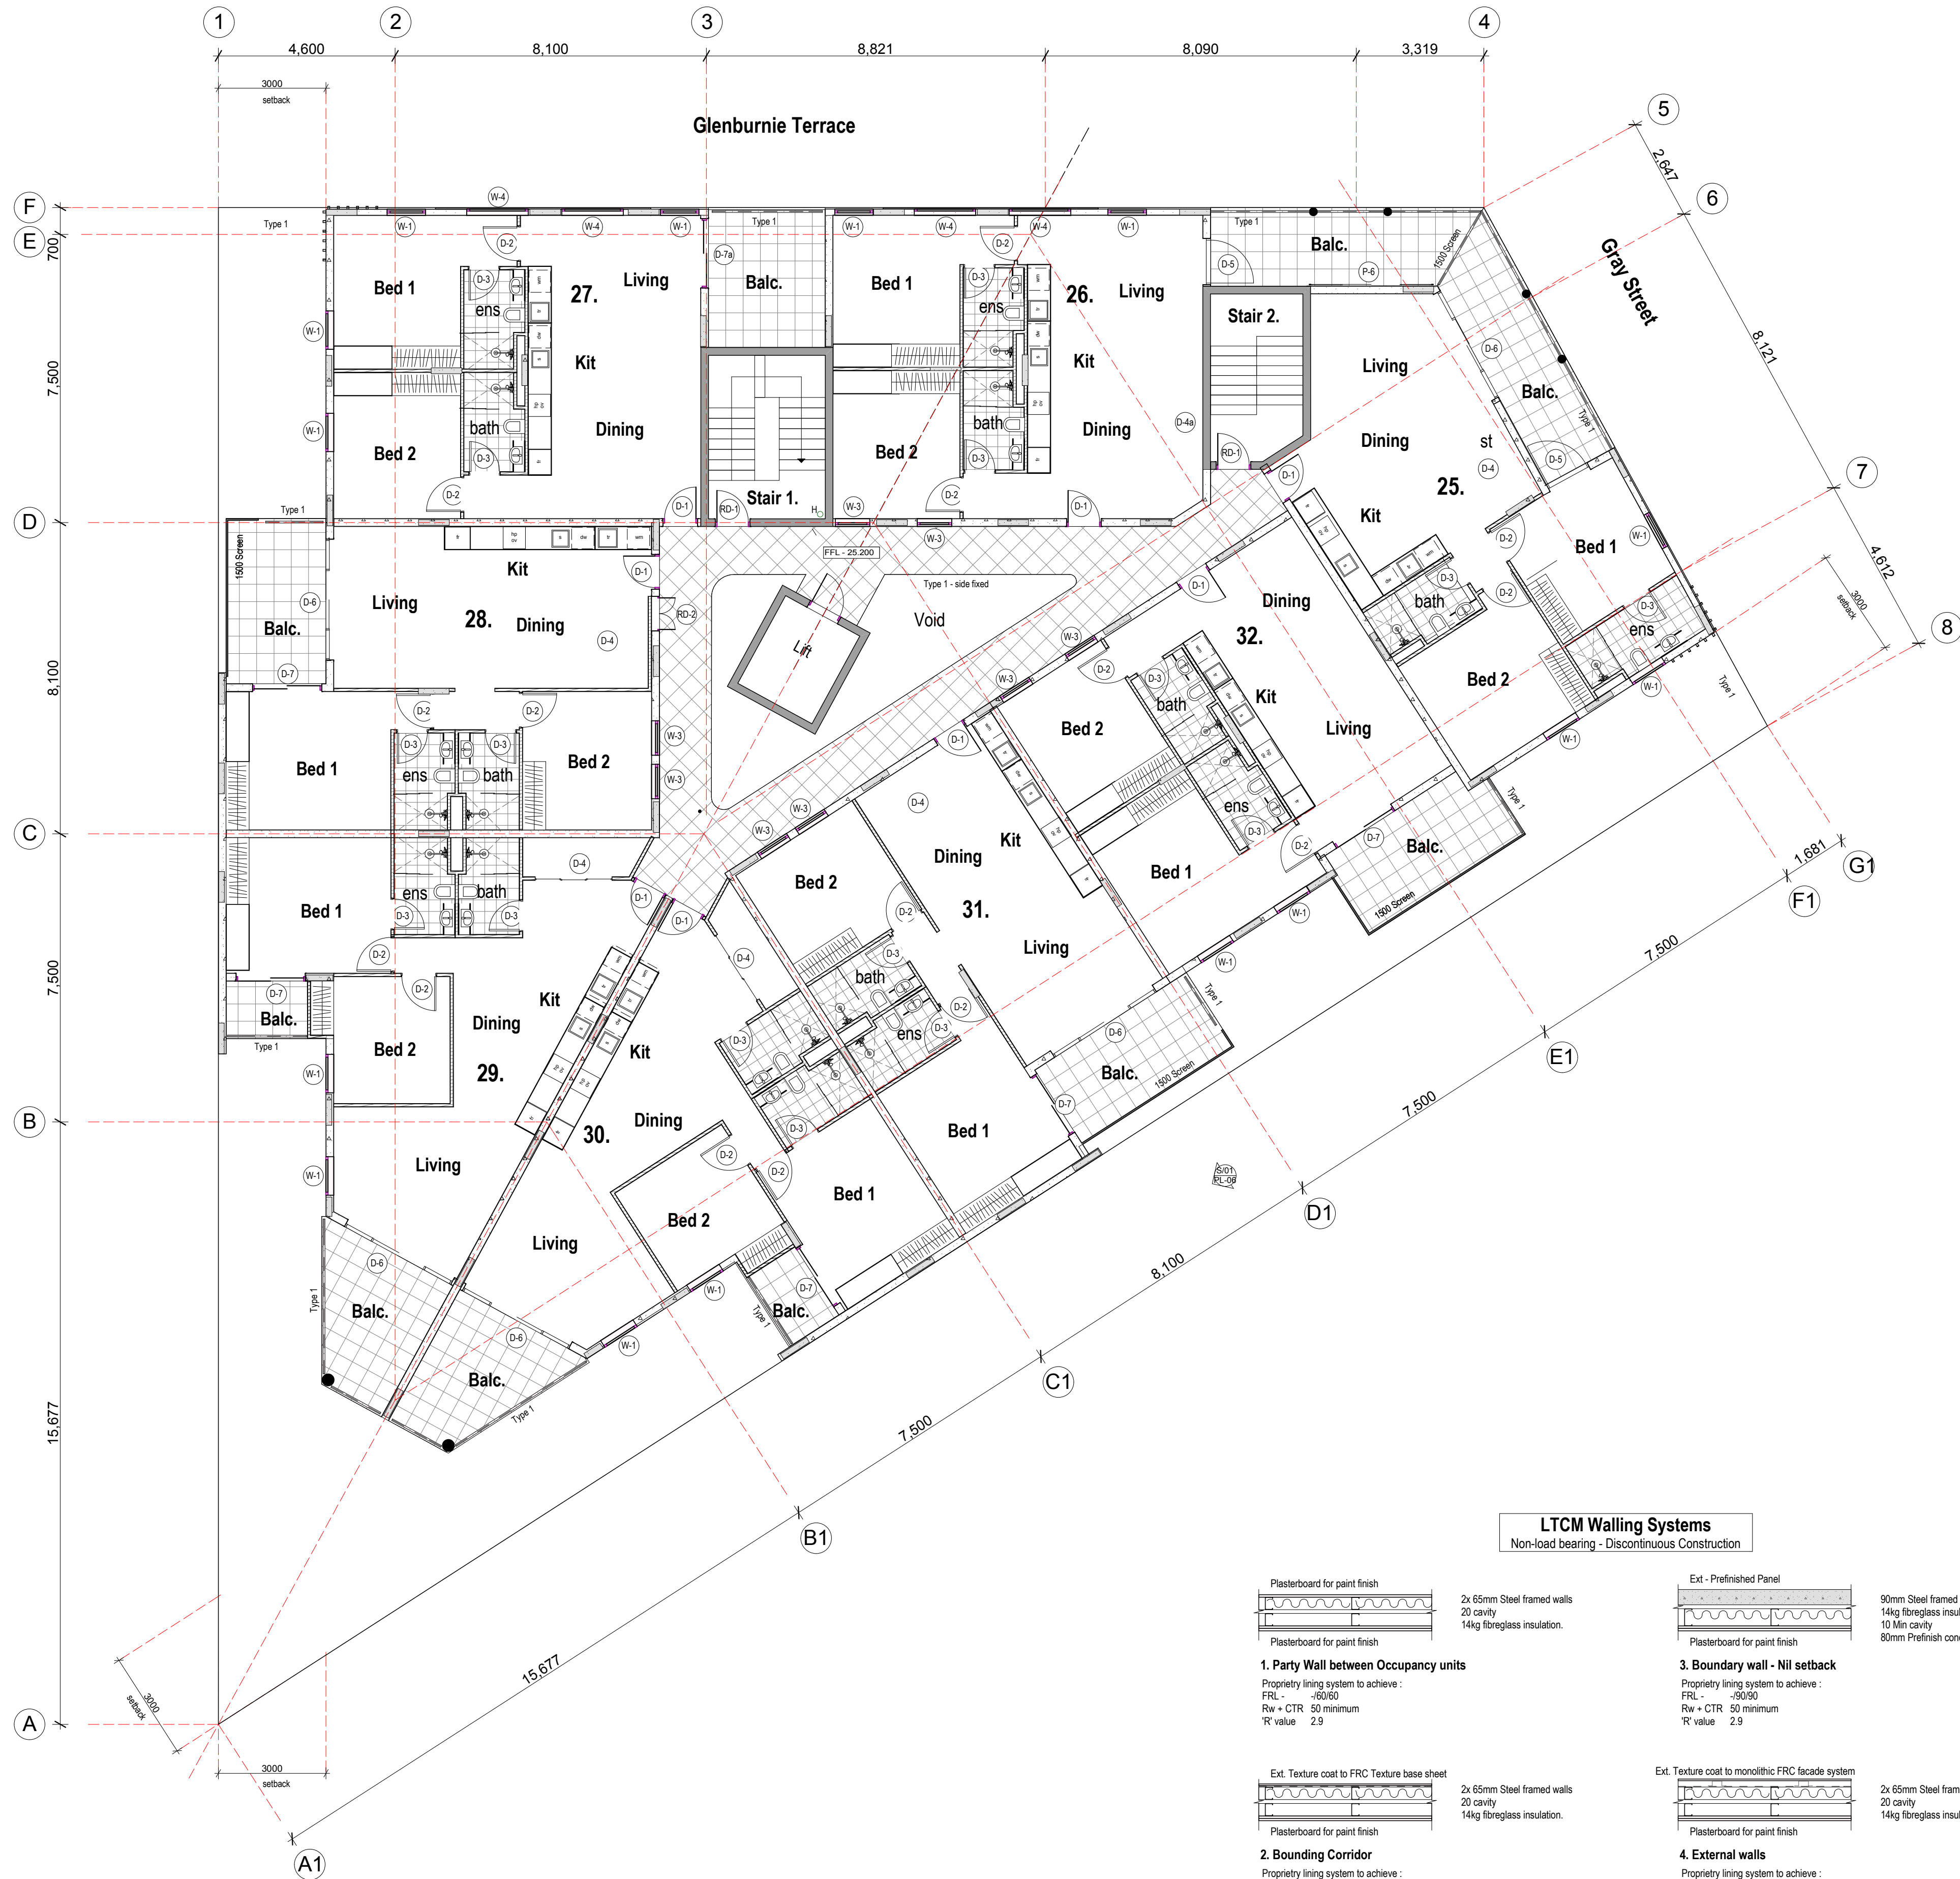

Level 4 Apartments
Scale 1:100


Wall Systems
Scale 1:20

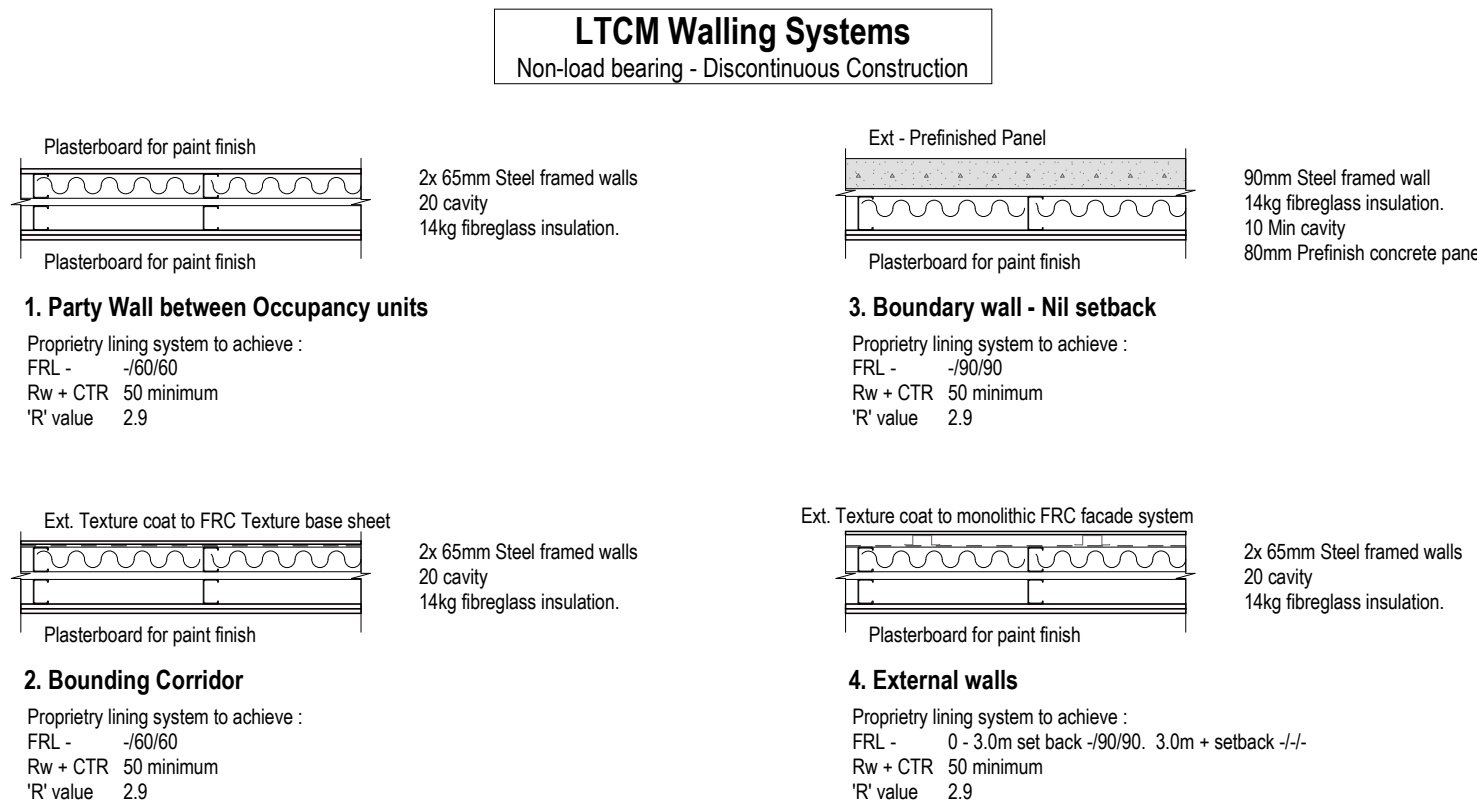



DOOR & WINDOW SCHEDULE 480 GRI, 1 Glenburnie Tce, Plympton
Rev 1 23-04-19
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All residential Glazed windows (double glazed) to achieve an acoustic rating of RW29 unless otherwise stated
Sliding Doors - manual operation under a force of not more 110N
Obscure glazing to all wet area windows

TYPICAL APARTMENT	Item	Dimensions	Description	Finish	BCA Compliance Requirements
	D1	900w x 2400h	to suit 2340x820 Fire door	Steel frame, selected paint finish	SCFD, FRL - /60/30. Latch or keyless operation from inside. Level transition at threshold. Minimum sound transmission rating of no less than 30Rw
	D2	900w x 2400h	to suit 2340 x 820 single door	Steel frame, selected paint finish	
	D3	800w x 2400h	to suit 2340 x 720 single door	Steel frame, selected paint finish	
	D4	2000w x 2400h	to suit 2340 x 650 Panel sliding doors	By Cabinet maker	
	D5	1200w x 2400h	to suit 2340x1120 Aluminium glazed door	Powder coated aluminium frame, clear glazed	
	D6	3150w x 2400h	Aluminium, Centre Sliding door	Powder coated aluminium frame, clear glazed	
	D7	1800w x 2400h	Aluminium, Sliding door	Powder coated aluminium frame, clear glazed	
	W1	1000w x 1600h	Aluminium, Awning window	Powder coated aluminium frame	Maximum opening 120mm
	W2	900w x 1900h	Aluminium, Awning window	Powder coated aluminium frame	Maximum opening 120mm
	W3	900w x 900h	Aluminium, Awning window	Powder coated aluminium frame	1500 sill, Maximum opening 120mm
	W4	1600w x 1000h	Aluminium, Awning window	Powder coated aluminium frame	Maximum opening 120mm


Typical Apartment Door Window Shedule
For more detail refer to the full schedule in the specification

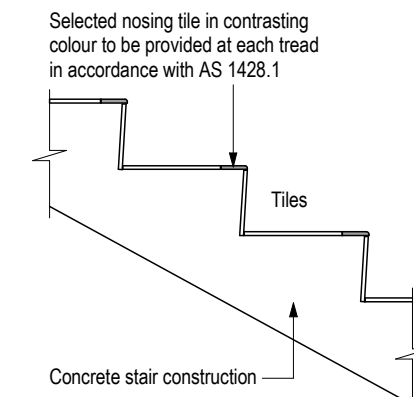


Stair Section
Scale 1:20

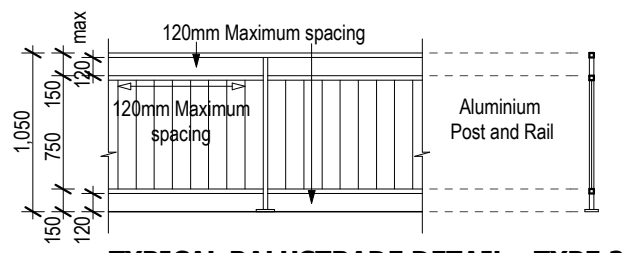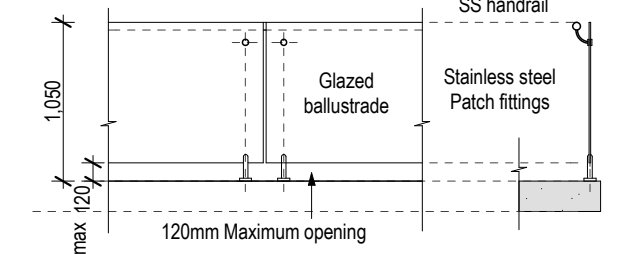





Typical Balustrades
Scale 1:50

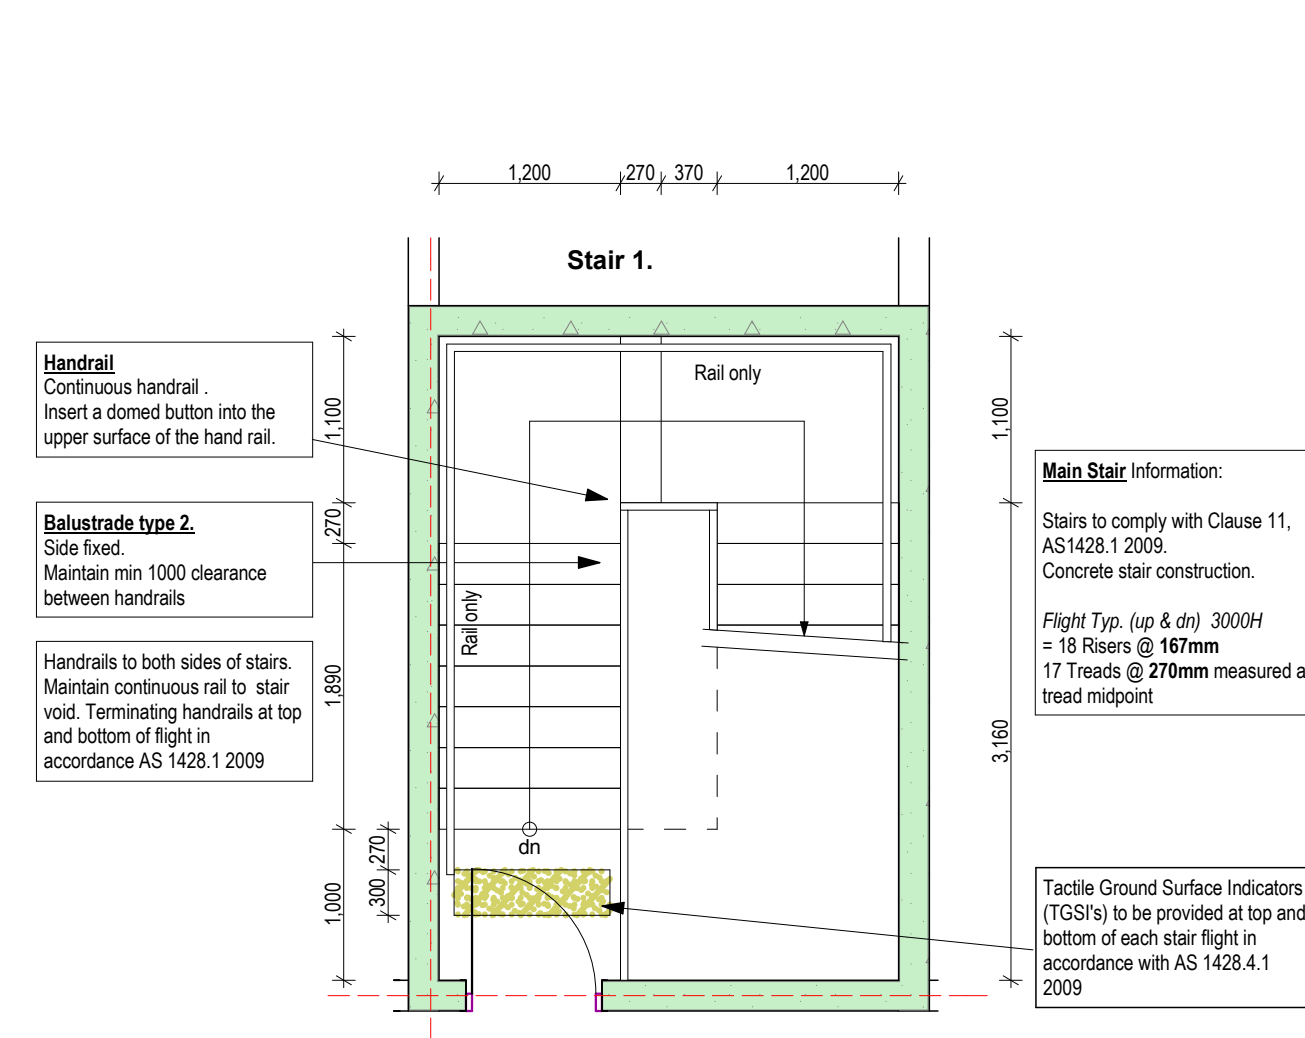

Stair 1.
Scale 1:50

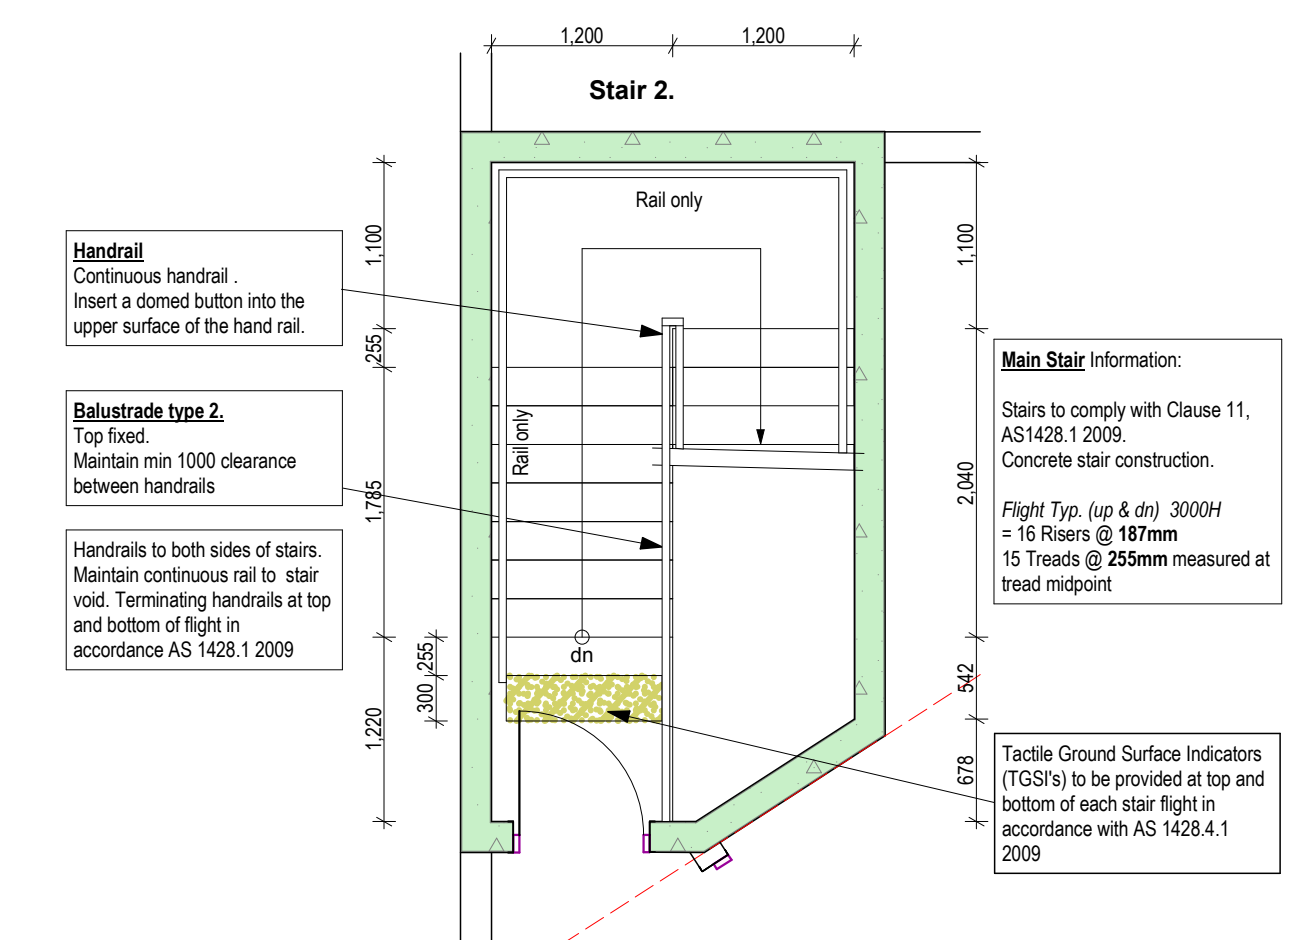

Stair 2.
Scale 1:50

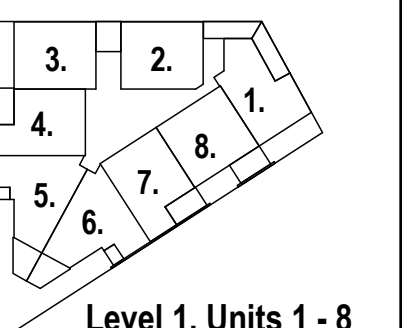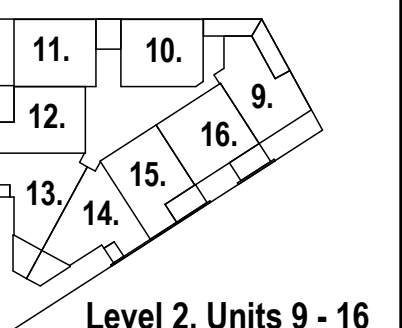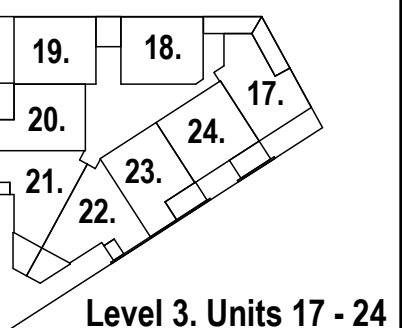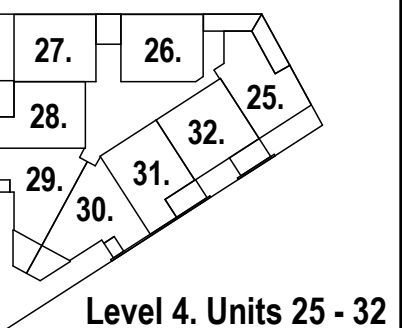

REV	DATE	DESCRIPTION
8	20/05/2019	LEVELS BASED MEZZANINE ADDED
A	20/05/2019	ISSUED FOR B.C.A. ASSOCIATION - BUILDING PERMIT
1	18/01/2019	ISSUED FOR CONSULTANT DESIGN INPUT

R B A N I Z E ARCHITECT
PTY LTD. A.B.N. 21 693 944 427
TEL: 08 938 1988 FAX: 083 8477
7233 BAGOT RD SUBURGO 5008
PO BOX 7002 SUBURGO 5008

The builder shall check and verify all dimensions refer any discrepancies to the Architect.
Do not scale the drawings. Drawings shall not be used for construction purposes until issued by the Architect for construction.

Client: **DSF**
Project Name: **PROPOSED 32 APARTMENTS**
1 Glenburnie Tce, Plympton
West Torrens

Drawing Title: **Level 4 Apartments**



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Status: **BCA** Job No.: **480-PLM**
Revision: **Rev-A** Drawing No.: **BL-05**
Plot Date: **30/05/2019**

For consultant design
Printed 30/05/2019




HALF SCALE at A3
FULL SCALE at A1


Level 4 Apartments

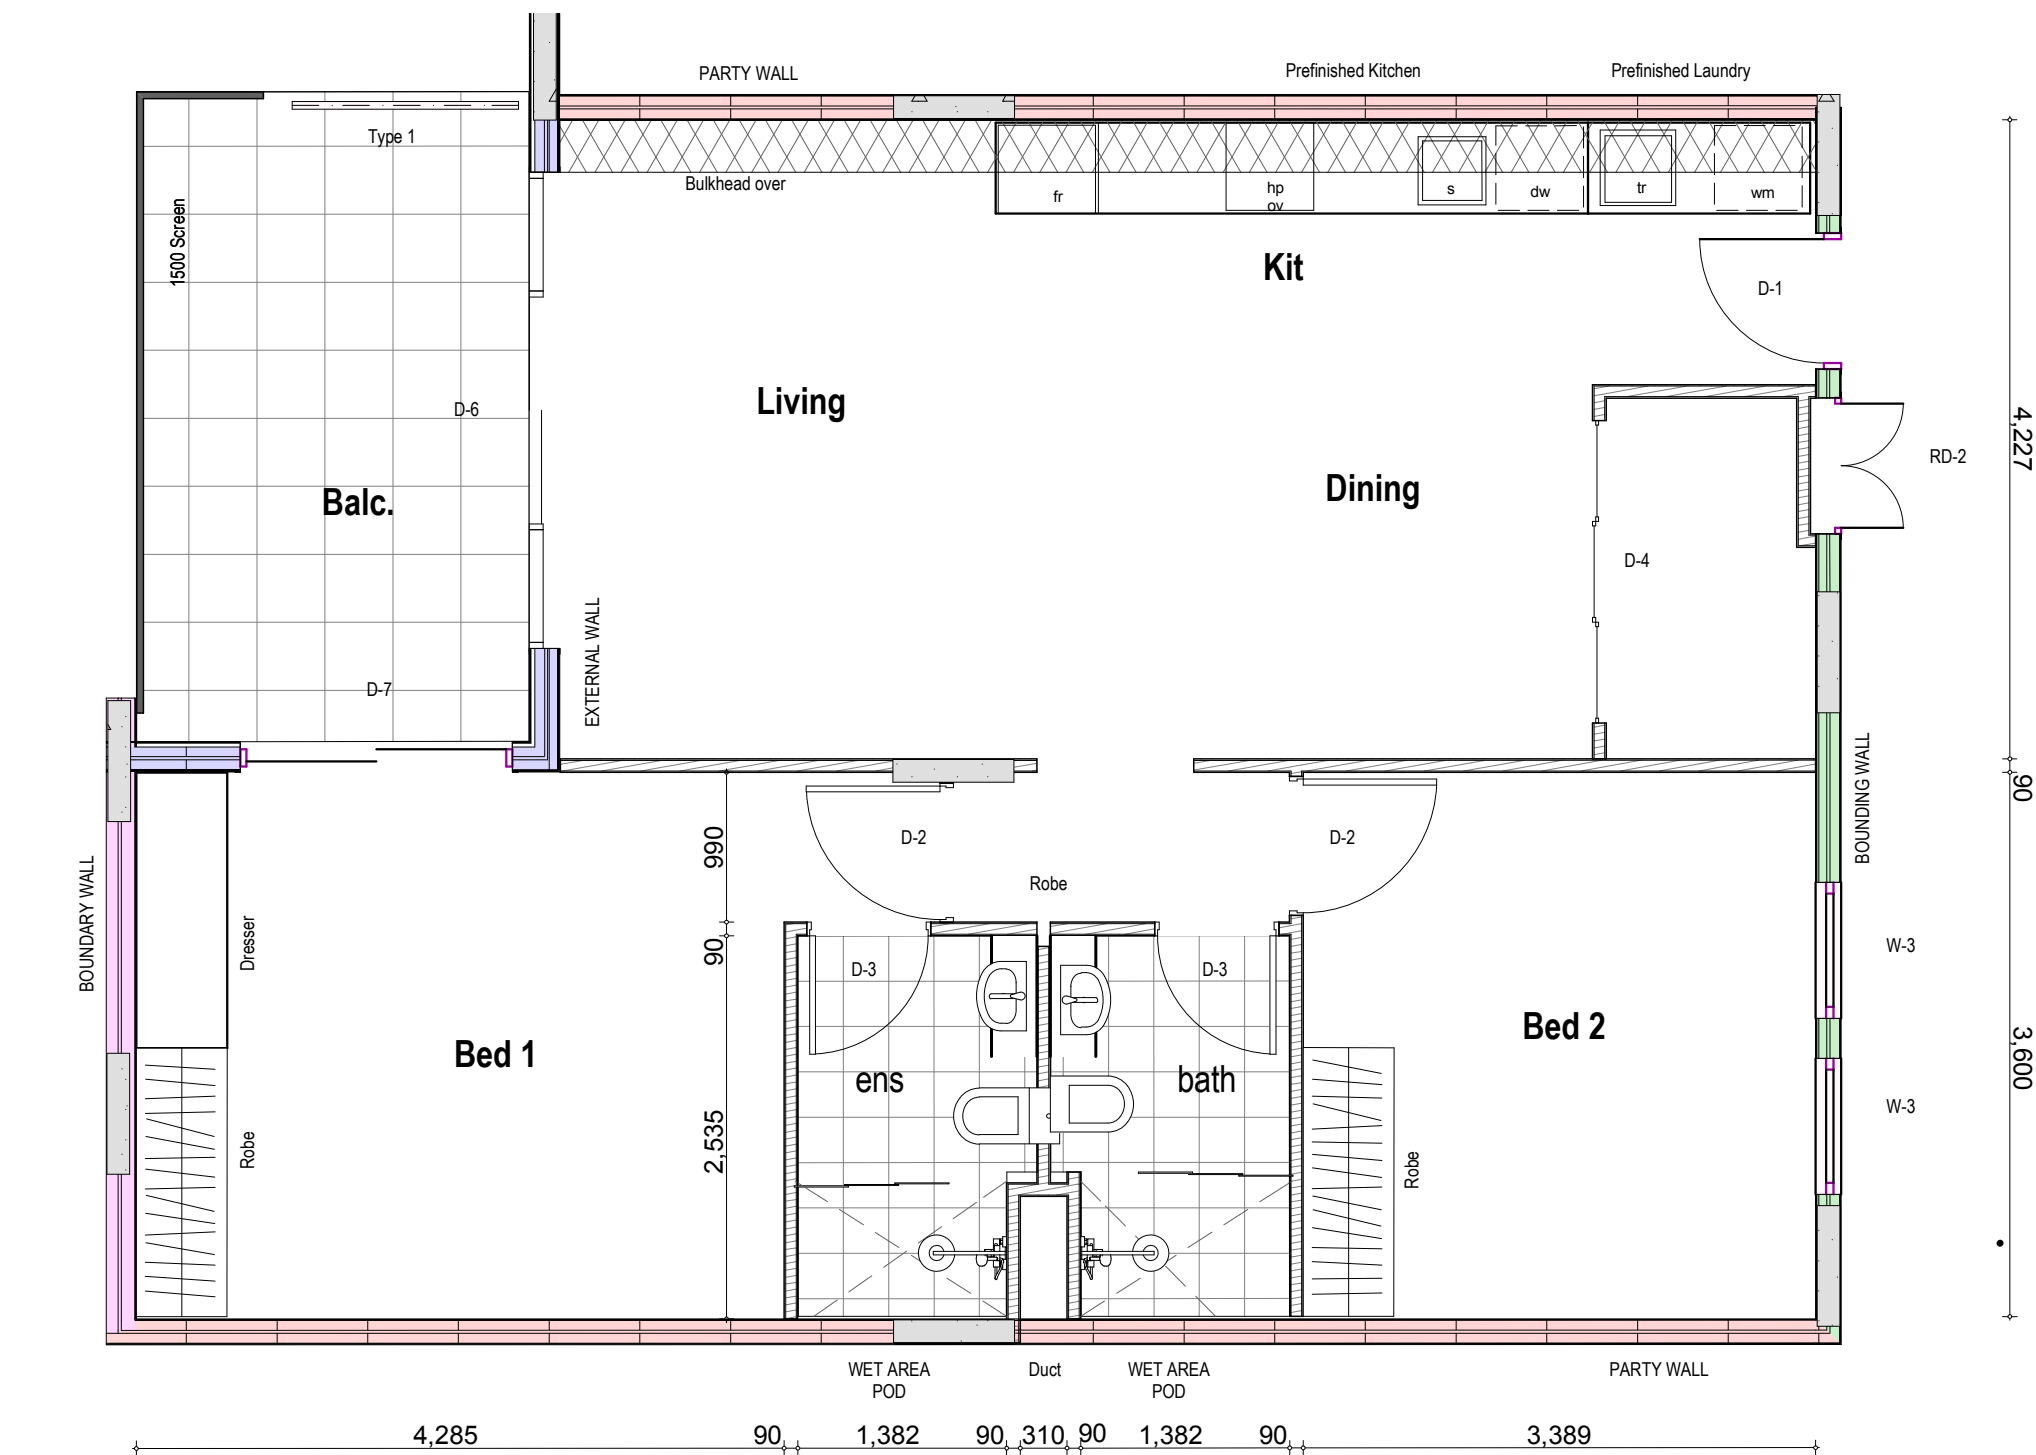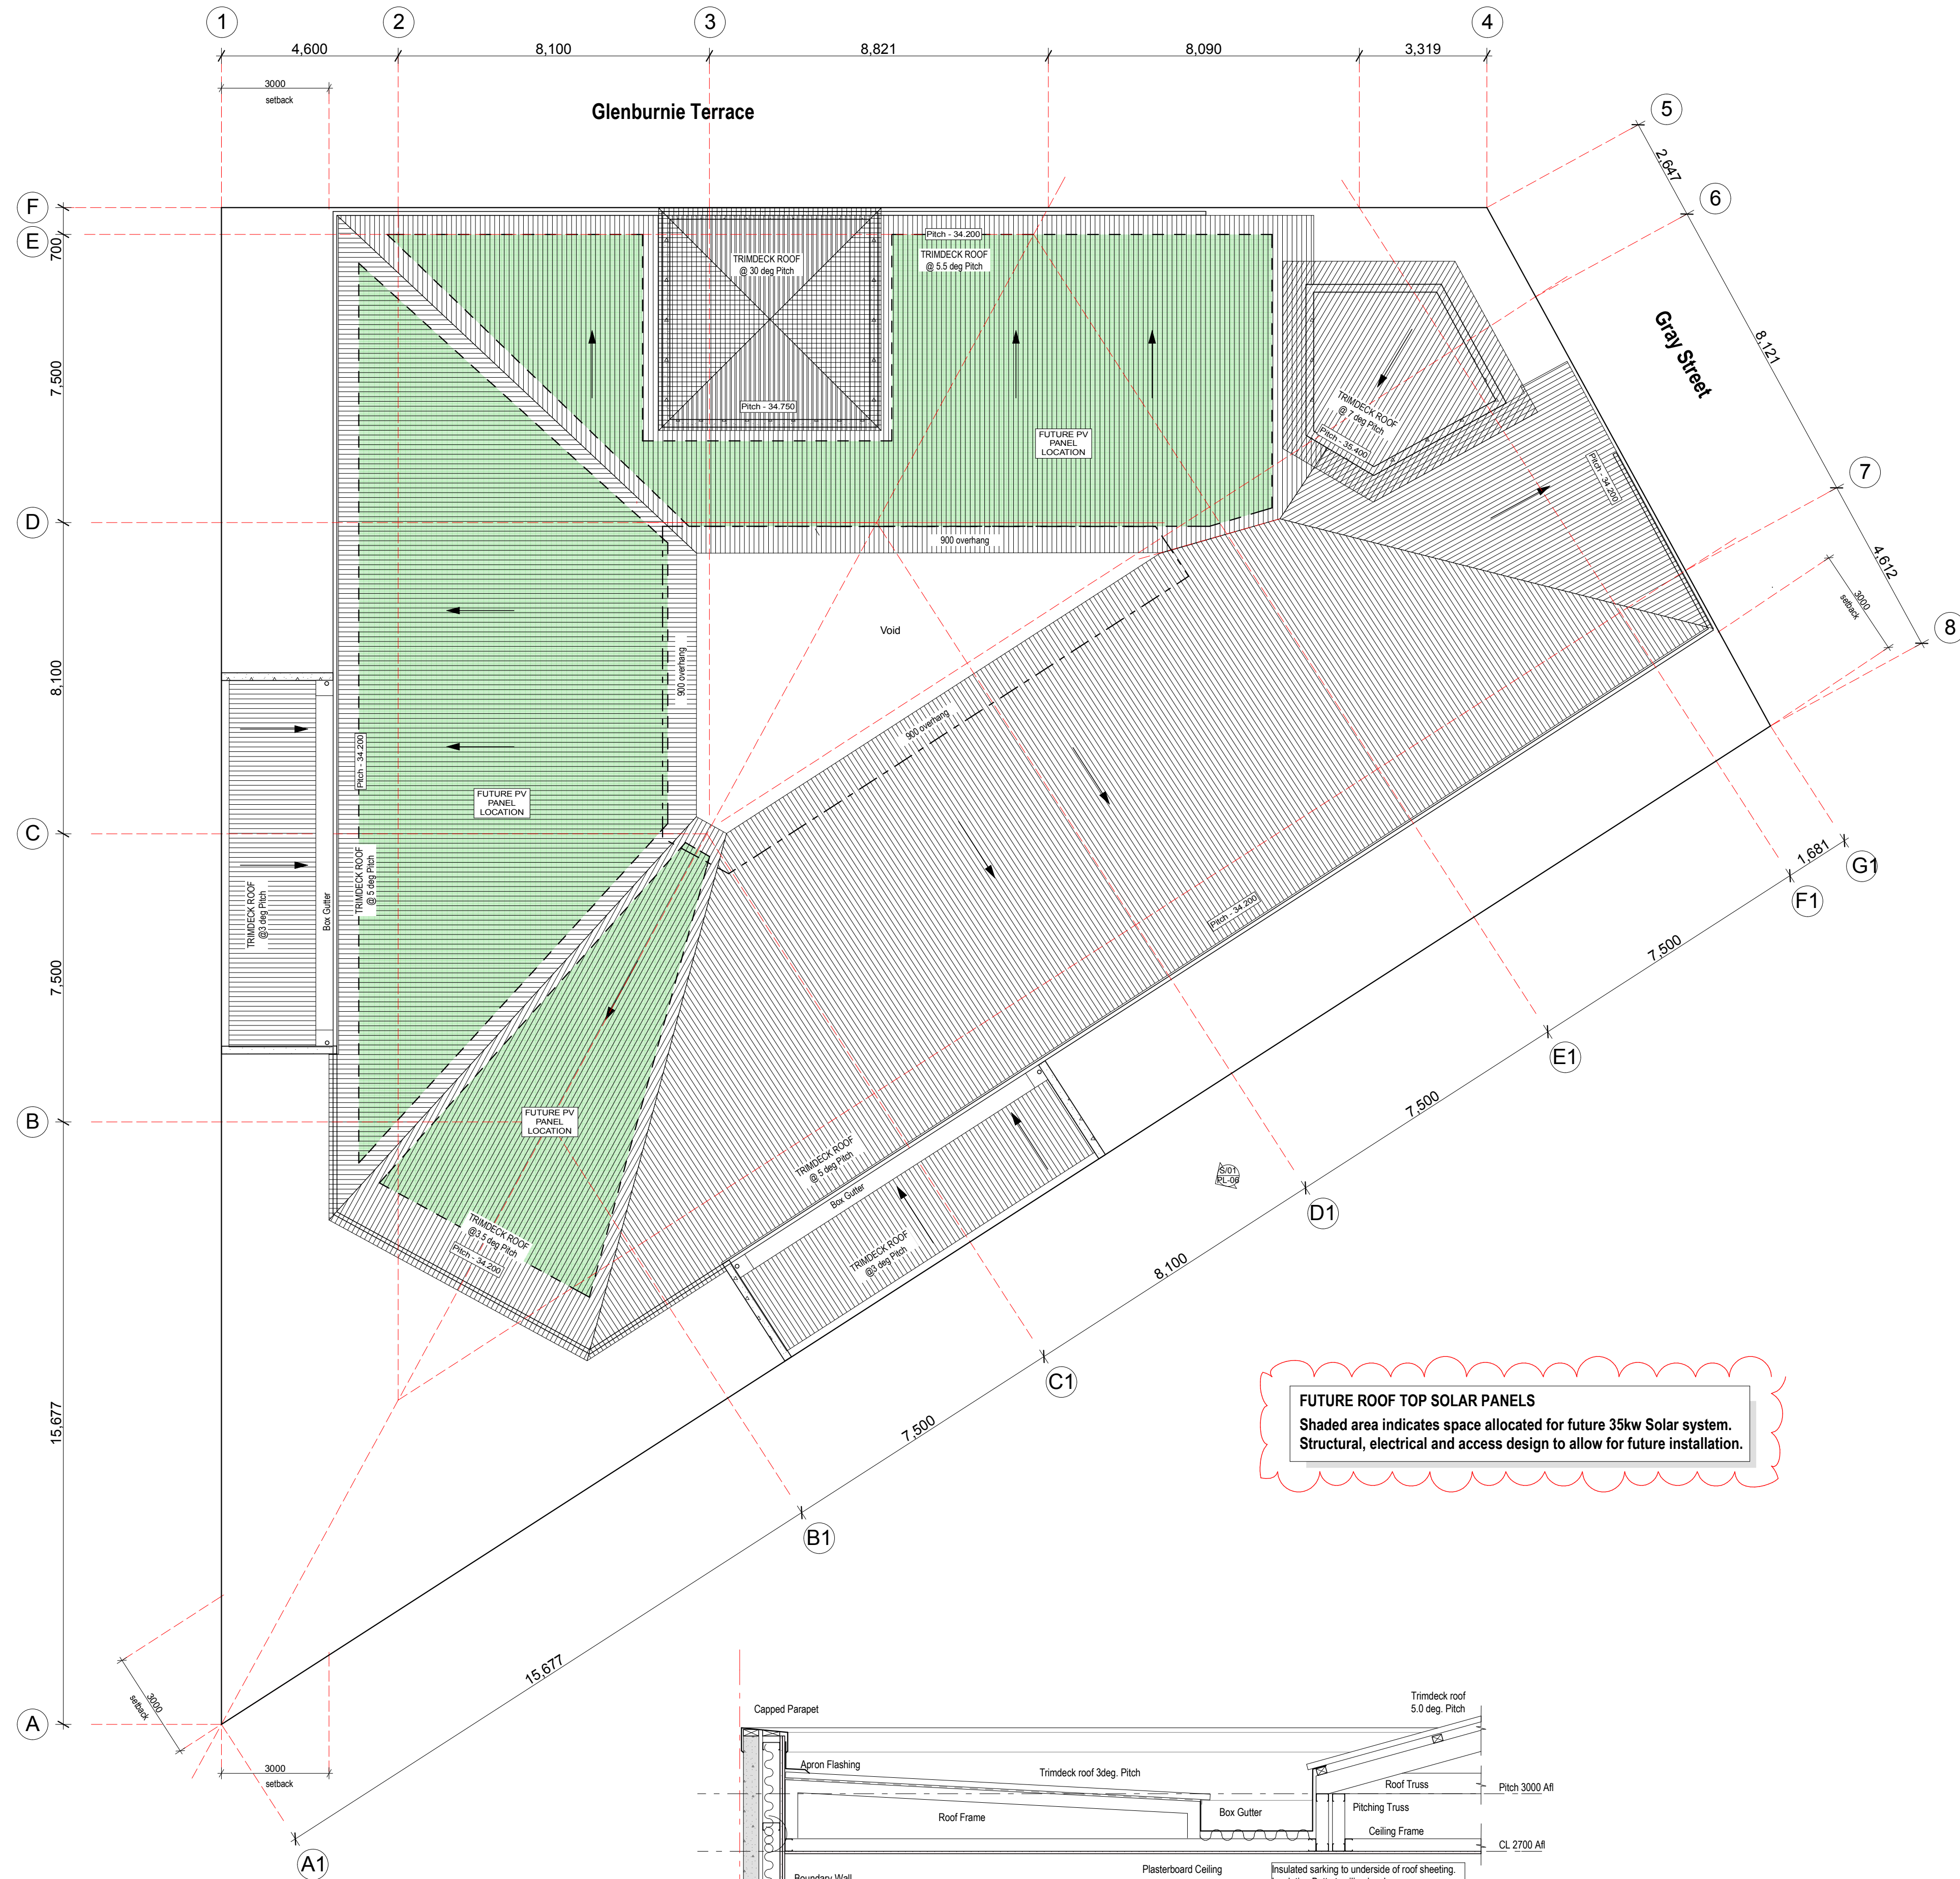

Typical Apartment
Scale 1:50

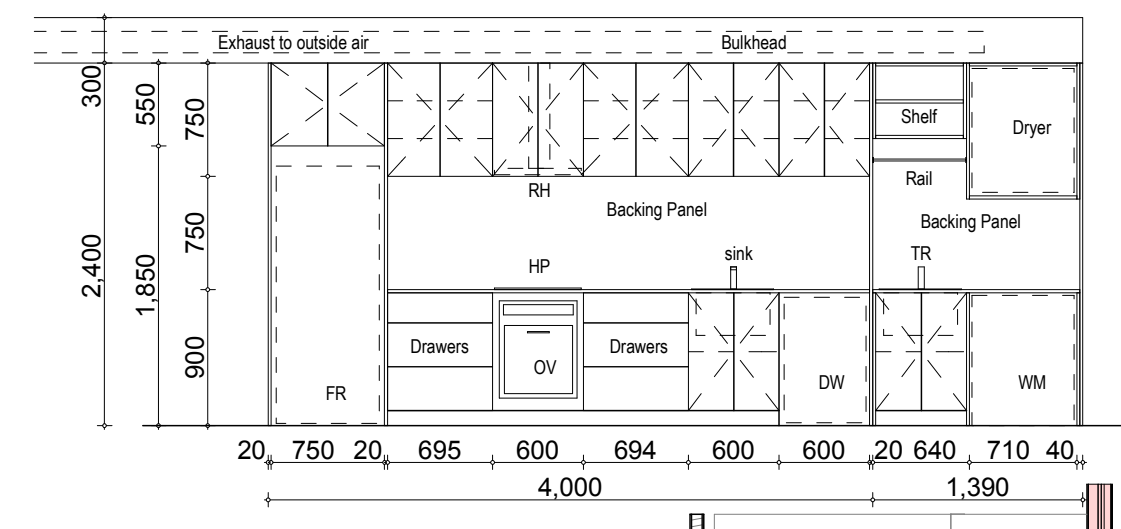


Prefinished Kitchen / Laundry
Scale 1:50

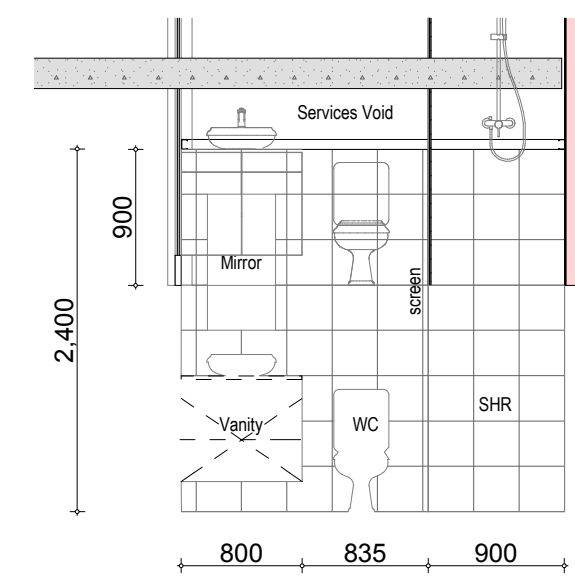

Bathroom Pod
Scale 1:50

LTCM Walling Systems

Non-load bearing - Discontinuous Construction

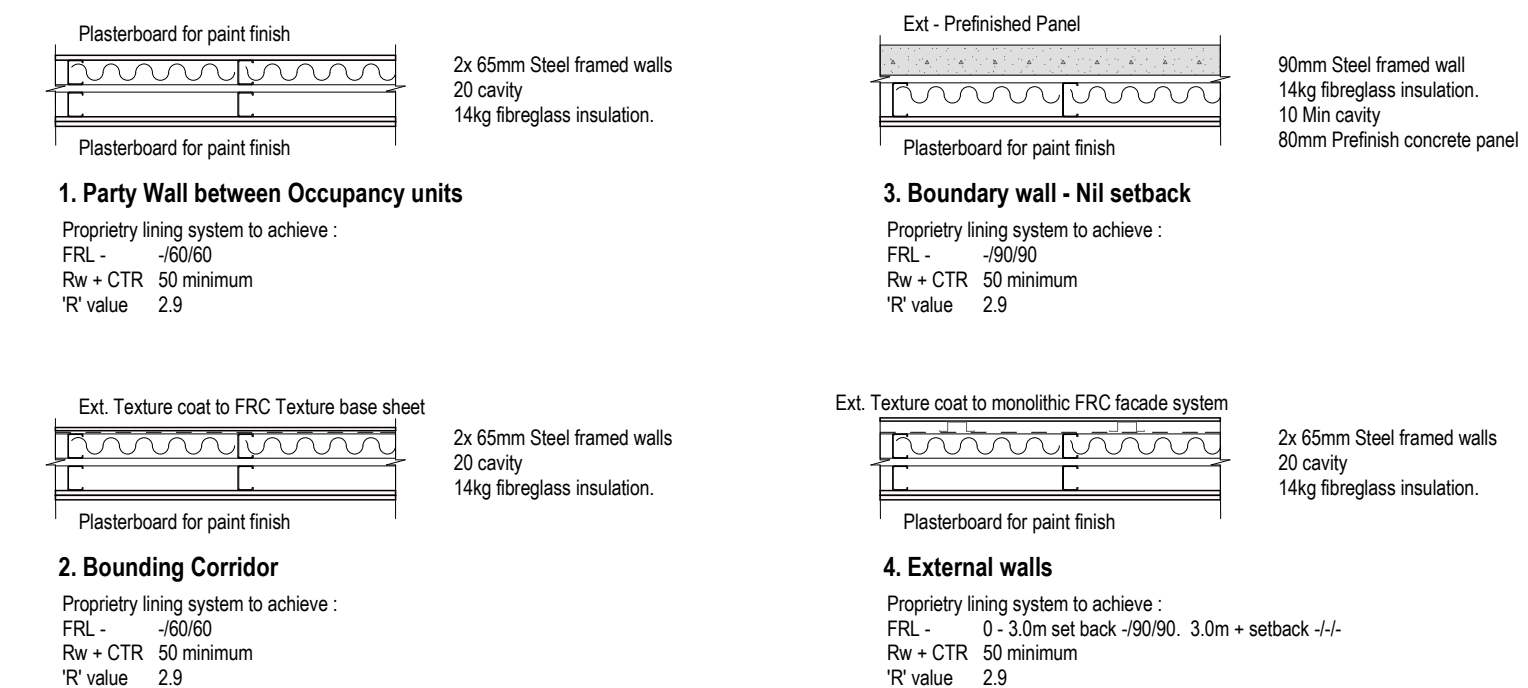


Wall Systems
Scale 1:20

For consultant design
Printed 30/05/2019



North Elevation
Scale 1:100

External Finishes	
	Heritage and/or recycled face brick.
	Adelaide sandstone corbelling.
	White Acrylic Texture coat applied finish Dulux reference colour Type 1.
	Pre finished panels reference colour Type FP1.
	Colourbond Roof Sheetting, Selection Type CB1.
	Pre finished panels reference colour Type FP2.
WINDOWS	
Powdercoat commercial frames - Colour Selection W1.	
RAINHEADS & DOWNPIPES	
Galv. painted to match windows - Colour Selection W1.	
ALUMINIUM FENCING PANELS, GATES	
Powdercoat to match windows - Colour Selection W1.	
AWNING STRUCTURE	
Galv. painted to match windows - Colour Selection W1.	
Balustrading	
Glazed, Patch fixed.	

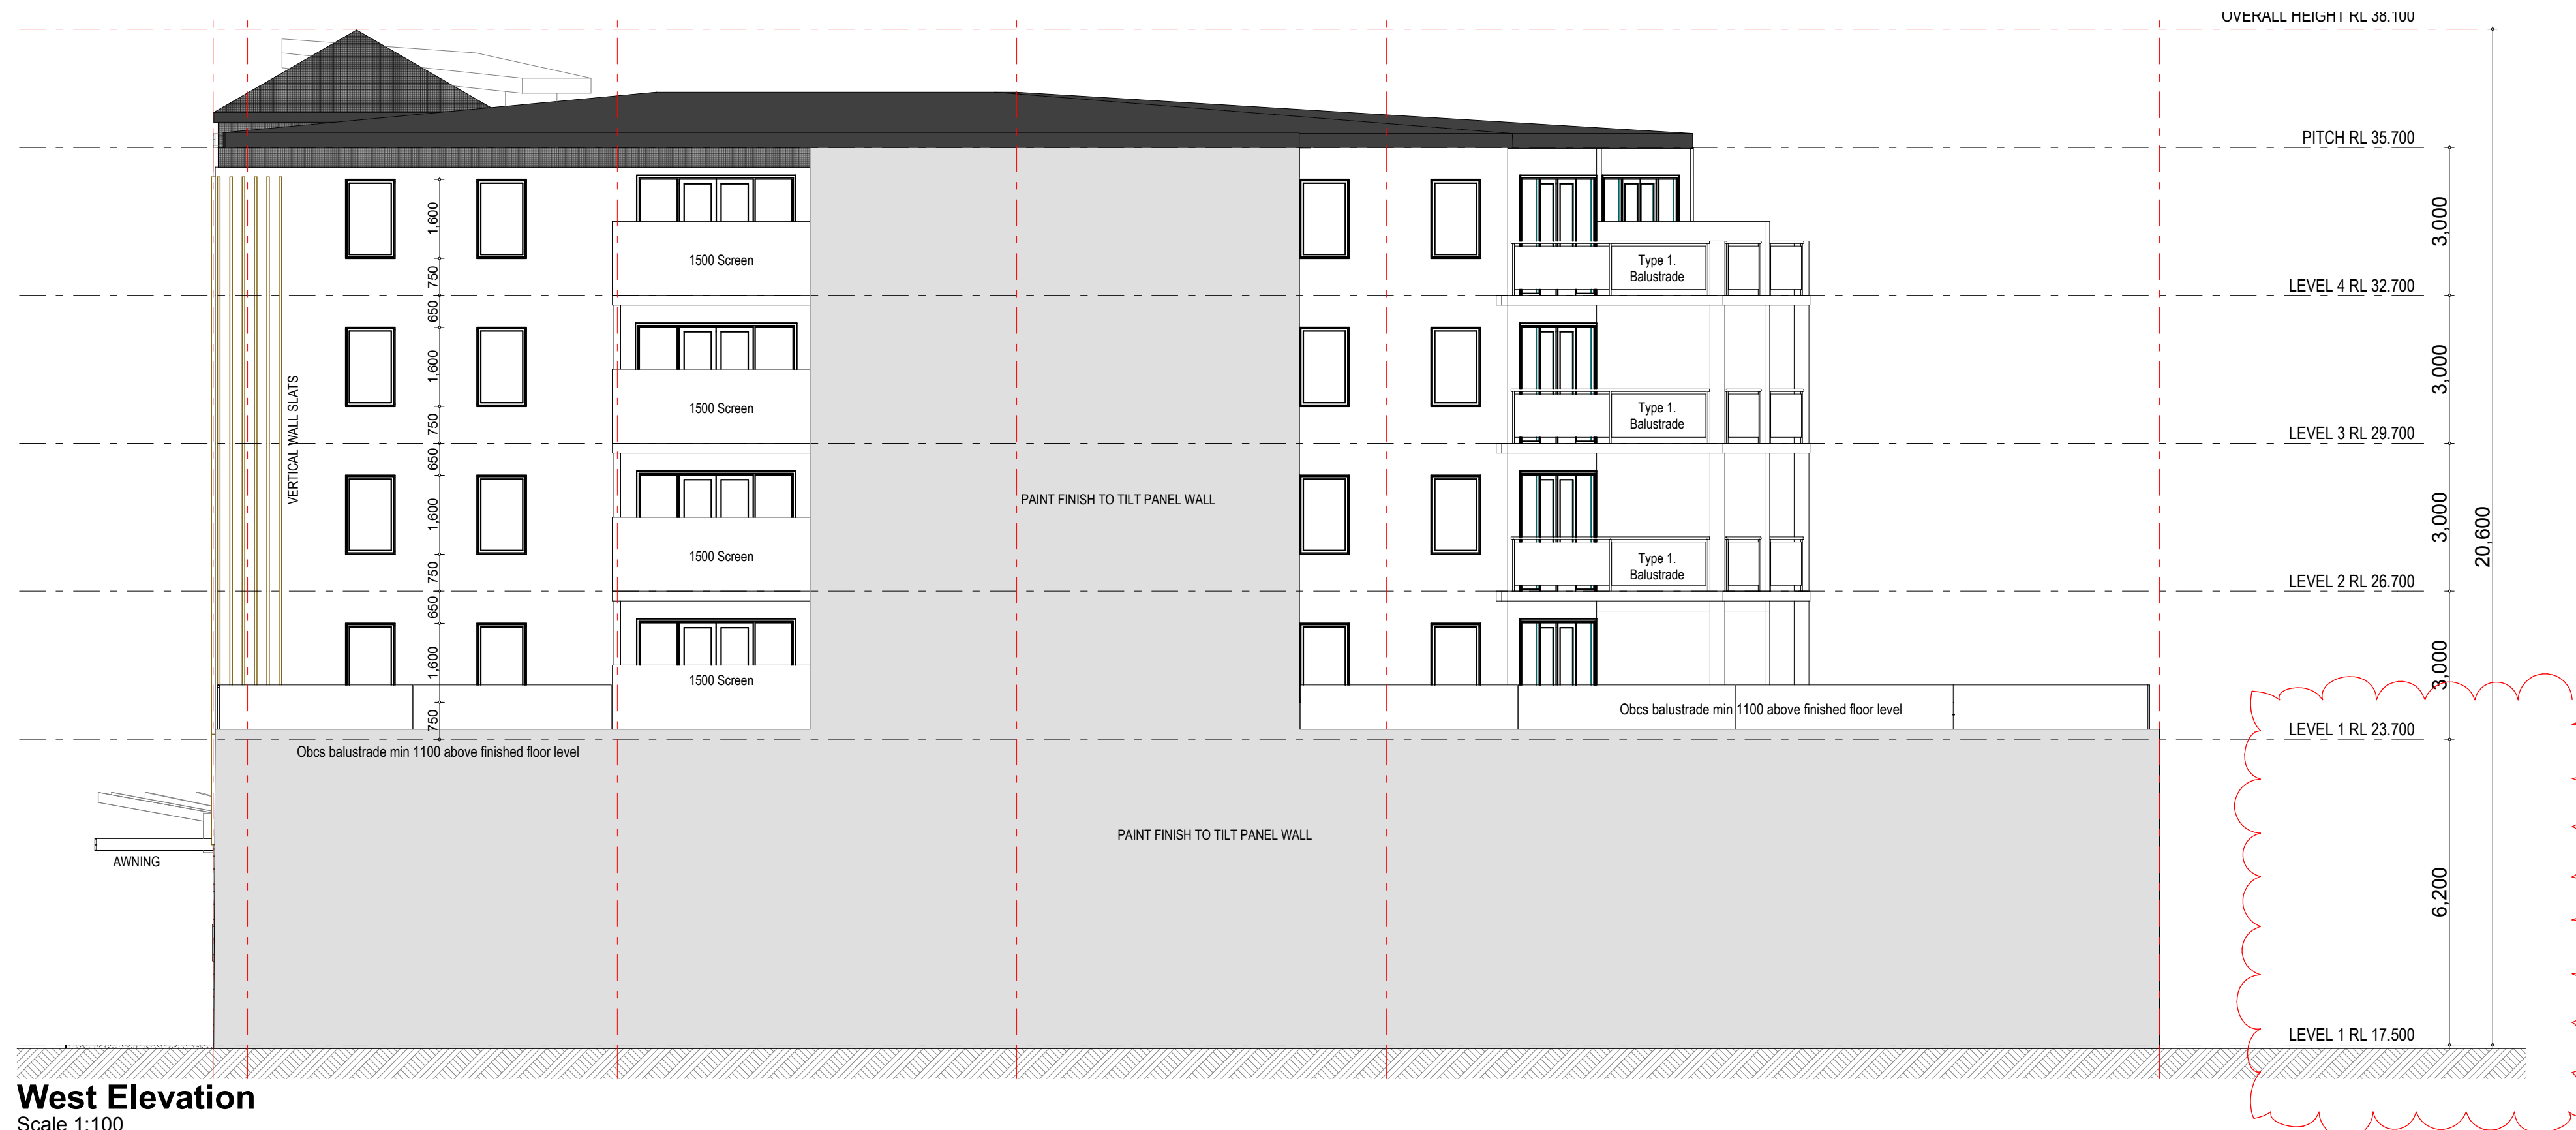

West Elevation
Scale 1:100

REV	DATE	DESCRIPTION
B	20/05/2019	LEVELS BASED MEZZANINE ADDED
A	20/04/2019	ISSUED FOR R.C.A. ASSOCIATION - BUILDING PERMIT
-	14/01/2019	ISSUED FOR CONSULTANT DESIGN INPUT

DESIGNED AND DRAWN BY: P.T. LTD. 21/05/2019
OF THE COPYRIGHT OF THESE PLANS

URBANIZE ARCHITECT
P.T. LTD. A.B.N. 21 693 044 427
TEL: 08 938 1988 FAX: 08 938 0477
233 BAGOTT RD SUBIACO 6008
PO BOX 7060 SUBIACO 6008

The builder shall check and verify all dimensions refer any discrepancies to the Architect. Do not scale the drawings. Drawings shall not be used for construction purposes until issued by the Architect for construction.

Client: **DSF**
Project Name: **PROPOSED 32 APARTMENTS**
1 Glenburnie Tce, Plympton
West Torrens

Drawing Title: **Elevations 1**

Scale: **AS SHOWN** Date: **18-04-2019**

Status: **BCA** Job No.: **480-PLM**

Revision: **Rev-A** Drawing No.: **BL-07**

Plot Date: **30/05/2019**



South Elevation
Scale 1:100

External Finishes	
	Heritage and/or recycled face brick.
	Adelaide sandstone corbelling.
	White Acrylic Texture coat applied finish Dulux reference colour Type 1.
	Pre finished panels reference colour Type FP1.
	Colourbond Roof Sheetting, Selection Type CB1.
	Pre finished panels reference colour Type FP2.
WINDOWS Powdercoat commercial frames - Colour Selection W1.	
RAINHEADS & DOWNPIPES Galv. painted to match windows - Colour Selection W1.	
ALUMINIUM FENCING PANELS, GATES Powdercoat to match windows - Colour Selection W1.	
AWNING STRUCTURE Galv. painted to match windows - Colour Selection W1.	
Balustrading Glazed, Patch fixed.	



East Elevation
Scale 1:100

REV	DATE	DESCRIPTION
B	20/05/2019	LEVELS BASED MEZZANINE ADDED
A	20/04/2019	ISSUED FOR R.C. ASSOCIATION - BUILDING PERMIT
-	18/01/2019	ISSUED FOR CONSULTANT DESIGN INPUT

Rurbanize ARCHITECT PTY LTD. A.B.N. 21 693 044 427 TEL. 08 938 1988 FAX 08 938 0477 233 BAGOT RD SUBIACO 6008 PO BOX 7062 SUBIACO 6008	

The builder shall check and verify all dimensions refer any discrepancies to the Architect. Do not scale the drawings. Drawings shall not be used for construction purposes until issued by the Architect for construction.

Client:
DSF
Project Name:
PROPOSED 32 APARTMENTS
1 Glenburnie Tce. Plympton
West Torrens

Drawing Title:
Elevations 2

Scale: AS SHOWN Date: 18-04-2019
Status: BCA Job No.: 480-PLM

Revision:
Rev-A Drawing No.:
BL-08


Plot Date: 30/05/2019




HALF SCALE at A3
FULL SCALE at A1

Elevations 2

For consultant design
Printed 30/05/2019

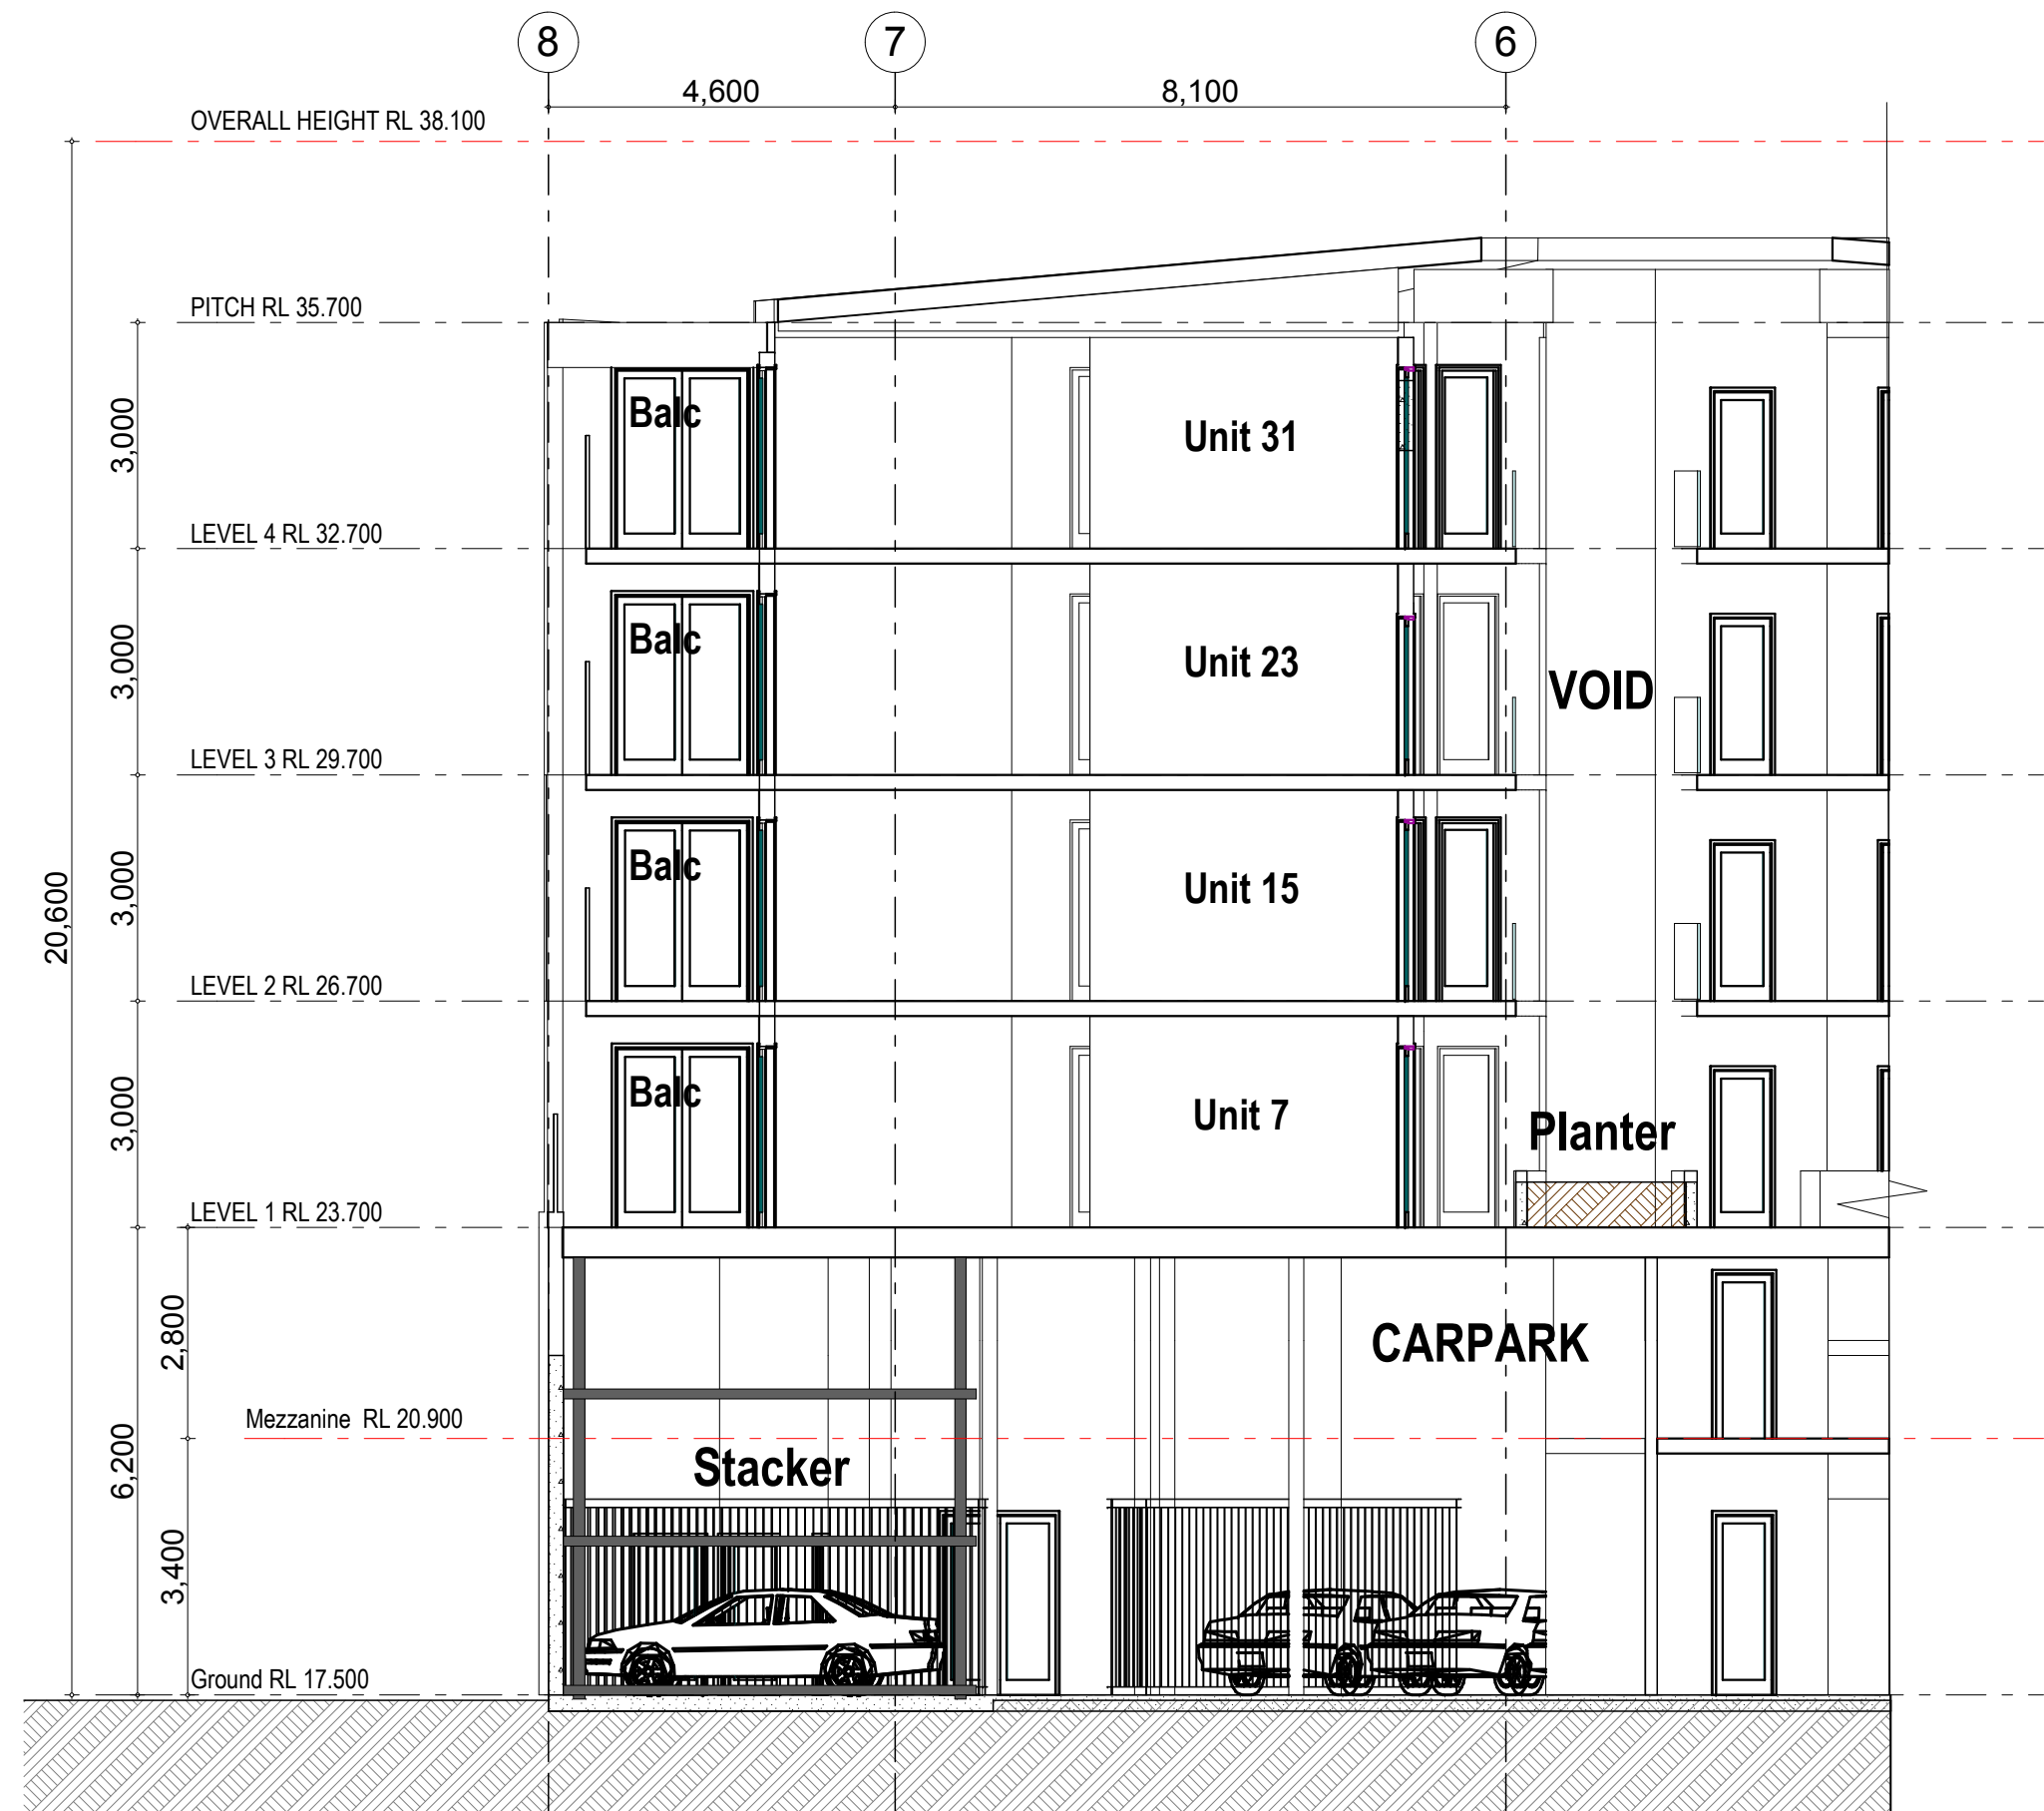

Section S1
Scale 1:100

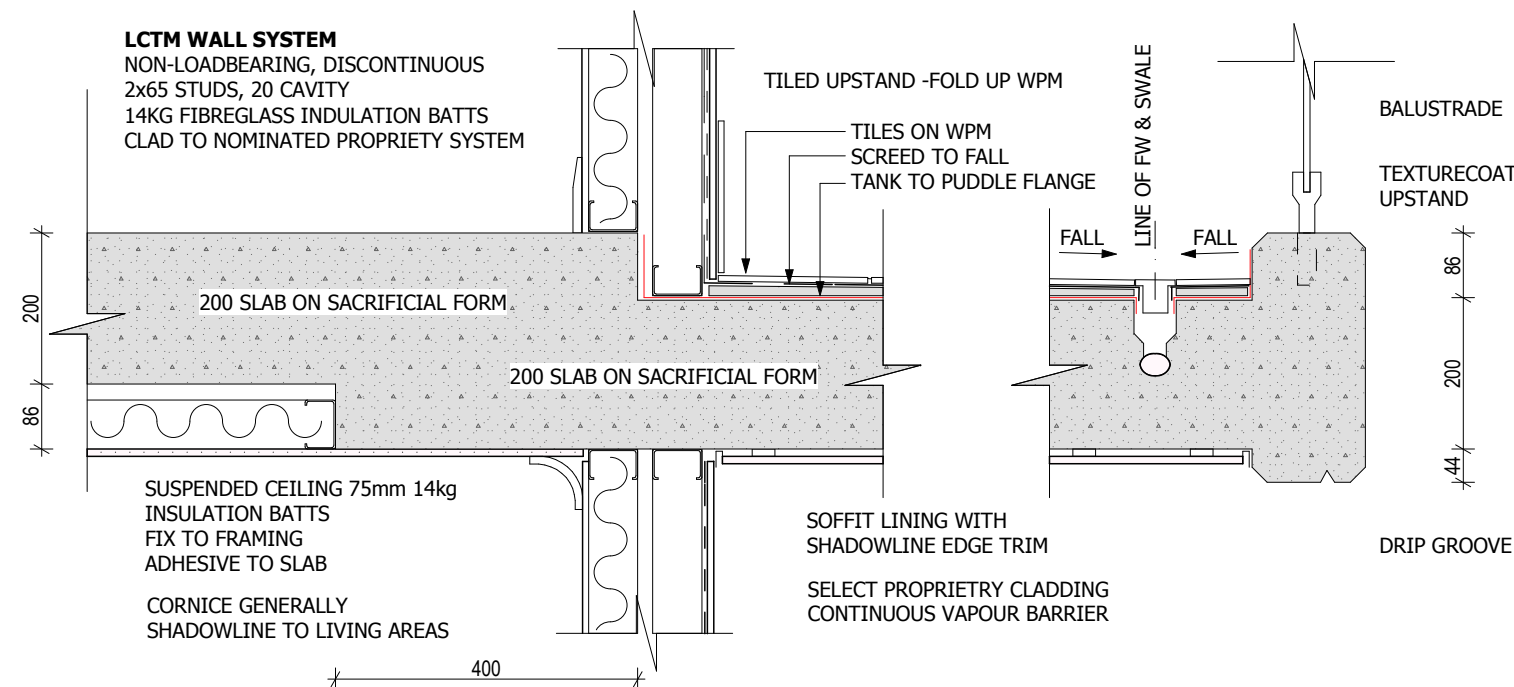


Typical Balcony
Scale 1:10

SECTIONS


HALF SCALE at A3
FULL SCALE at A1

Section , Details

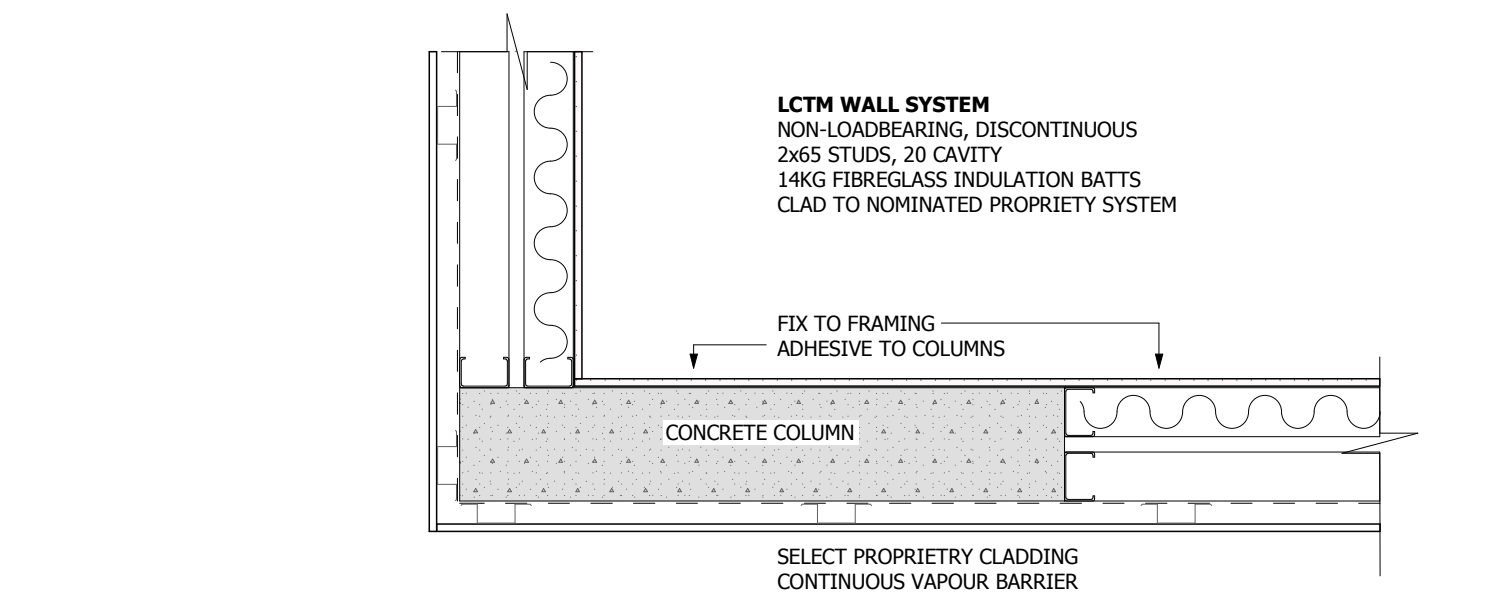


LTCM Wall System

Scale 1:10

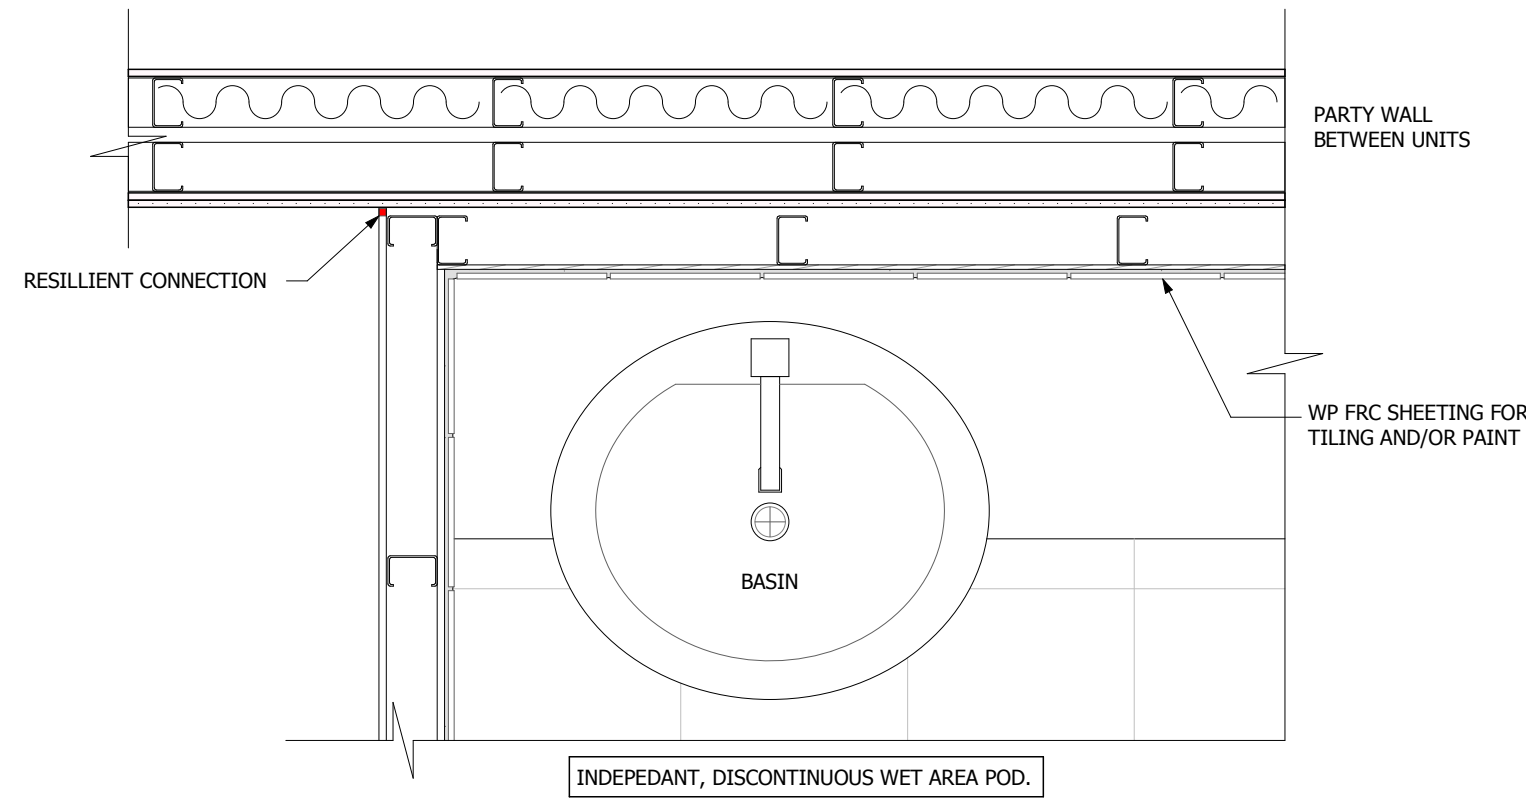


Discontinuous Wet Area Pod

Scale 1:10

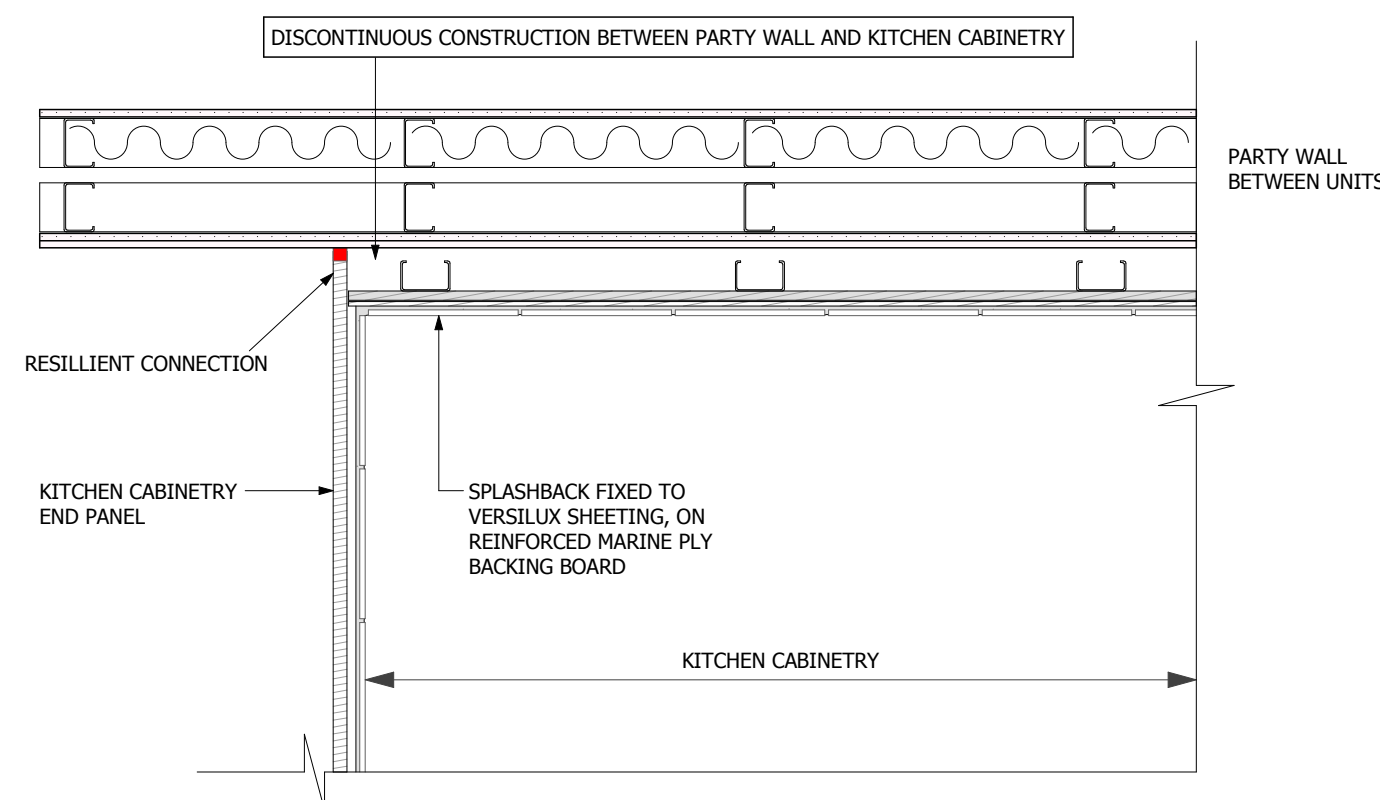

Discontinuous Kitchen / Laundry Cabinetry

Scale 1:10

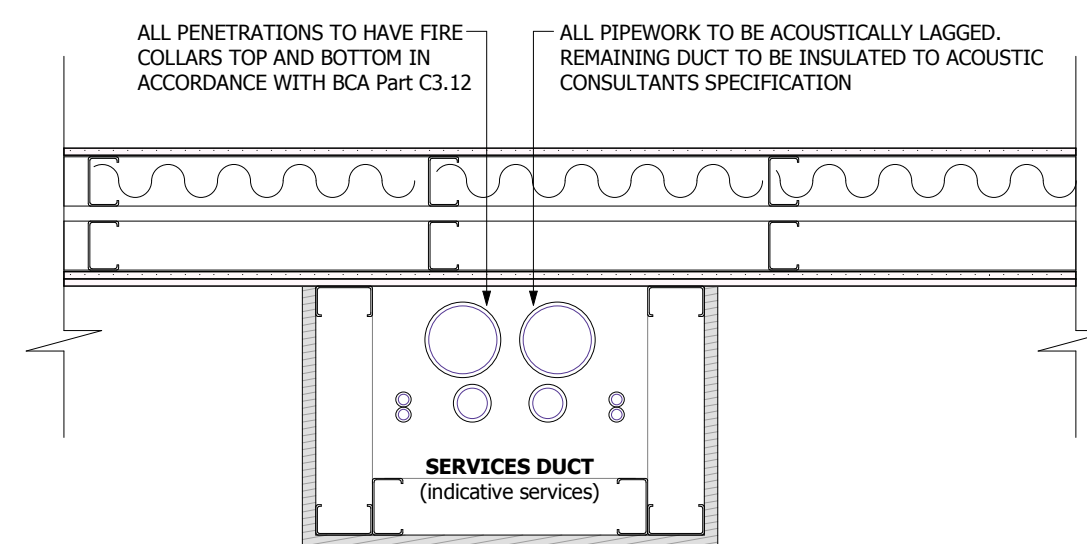

Service Ducts to achieve FRL 120/120/120
Acoustic Rw + Ctr (Airbourne) 40

Access Panels to Service Ducts to achieve FRL -/60/30

Penetrating Services in Walls & Floors in FRL rated elements need to be protected with a material that will maintain the required FRL. The Builder is to provide protection to these penetrations as required by all consultants, conforming with the BCA and relevant Australian Standards

Typical Plumbing / Service duct.

Scale 1:10

PLAN DETAILS

CONSTRUCTION NOTES

Floors - to structural engineers detail

On Ground: Reinforced concrete slab on ground

Above Ground: Level 1 suspended concrete transfer slab

LTCM system - Level 2,3,4 suspended concrete slab on sacrificial form.

Walls

Ground:

Concrete panels, Load bearing blockwork, Steel framing as nominated. FRLs as nominated.

Flushed or lined to habitat areas for paint finish. Off form paint finish to carpark and service areas.

LTCM system - Non load bearing, discontinuous construction, Double steel studs.

Single steel stud to internal walls of each occupancy unit.

Ceilings

Ground:

Off form concrete soffit to arpark and service areas. Suspended plasterboard ceiling to

Habitat / common areas.

Residential:

LTCM system - Levels 1,2 & 3. Suspended plasterboard ceiling on independant C section framing.

Level 4. Plasterboard ceiling to underside of roof structure with R3.0 bulk insulation.

Wet Area Pods

Bath / Ensuite:

LTCM system - Fully Prefinished pods. Steel framed walls, floors and ceilings. Tiling, fittings,

fixtures, Electrical and Mechanical services in place prior to installation. Ceiling discontinuous from,

and nom 300mm below, slab soffit above.

Roof

Timber framed roof structure to AS 1684. Selected colorbond sheeting over insulated sarking.

Environmental

All exhaust fans to be sealed and fitted with self closing dampers.

All doors and windows to be fitted with air seals.

All tap fittings and sanitary dual flush systems to be 4 Star WELS rated.

All shower heads to be minimum 3 Star WELS rated.

Windows and Doors

Powdercoated, Aluminium framed Sliding doors and Awning windows.

Doors and windows double glazed.

Balconies

Tiled.

Patch fixed glass balustrades.

Feature soffits. LED lighting.

Security

Video entrance Intercom and Secured parking

Heating and Cooling

Split system, reverse cycle. Living area and Master Bedroom.

Bed room ceiling fans.

Laundry, bathrooms and Kitchen cooktop exhausted to external air.

CONSTRUCTION NOTES

REV	DATE	DESCRIPTION
8	18/05/2019	LEVELS BASED MEZZANINE ADDED
A	20/04/2019	ISSUED FOR BCA ASSESSMENT - BUILDING PERMIT
-	14/01/2019	ISSUED FOR CONSULTANT DESIGN INPUT

DESIGNED AND DRAWN BY: J. B. ARCHITECT
OF THE COPYRIGHT OF THESE PLANS

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PO BOX 1960 SUBIACO 6008

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1 Glenburnie Tce. Plympton
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Drawing Title:
Section , Details

Scale: AS SHOWN Date: 18-04-2019
Status: BCA Job No.: 480-PLM

Revision:
Rev-A Drawing No.:
BL-09

Plot Date: 30/05/2019

